

Office of the Town Clerk

Town of Brookfield | 645 N. Janacek Road, Brookfield, WI 53045 Office: 262-796-3788 | Clerk@TownofBrookfield.com

MEETING AGENDA

Town Board Eric Gnant Room
Tuesday, July 15, 2025
Utility District No. 1 TOB Municipal Building
7 p.m. Sanitary District No. 4 645 N. Janacek Rd., Brookfield, WI

- 1. Call to Order & Roll Call.
- Meeting Notices.
- 3. Approval of Agenda.
- 4. Approval of Minutes:
 - a. July 1, 2025 meeting of the TB, UD1, SD4.
- 5. Citizen Comments: Three-minute limit.
- 6. Old Business: None.
- 7. New Business:
 - a. Discussion and possible action regarding the appointment of Jason Krogsund to the Community Development Authority.
 - b. Convene into <u>CLOSED SESSION</u> pursuant to Wis. Stat. § 19.85(1)(e) Deliberating or negotiating the purchasing of public properties, the investing of public funds, or conducting other specified public business, whenever competitive or bargaining reasons require a closed session: Municipal Recycling Dividend Program
 - c. Reconvene into **OPEN SESSION**, according to Wis. Stat. §19.85(2), for any necessary action resulting from the Closed Session.
- 8. Departments, Boards, Committee/Commission Reports/Recommendations:
 - a. Plan Commission:
 - 1. Discussion and possible action regarding the request by Ryan Janssen, representing Avery & Birch, for final approval of a new building consisting of a one-story salon suite facility, located at 21055 Crossroads Circle.
- Approval of Vouchers and Checks.
- 10. Communication and Announcements.
- 11. Adjourn.

Posted July 11, 2025 Emily Howells, Deputy Clerk



Office of the Town Clerk

Town of Brookfield | 645 N. Janacek Road, Brookfield, WI 53045 Office: 262-796-3788 | Clerk@TownofBrookfield.com

	MEETING MINUTES	
	Town Board	Eric Gnant Room
Tuesday, July 1, 2025	Utility District No. 1	TOB Municipal Building
7 p.m.	Sanitary District No. 4	645 N. Janacek Rd., Brookfield, WI

Call to Order & Roll Call.

Chairman Henderson called the meeting to order at 7:00 p.m.

Present: Chairman Keith Henderson; Supervisors Steve Kohlmann, John Schatzman and Ryan Stanelle. Supervisor John Charlier was absent and excused.

A quorum was met (4-1).

Staff Present: Fire Chief John Schilling, Town Attorney Michael Van Kleunen, Administrator/Interim-Clerk Tom Hagie and Deputy Clerk Emily Howells.

Meeting Notices.

Hagie confirmed the meeting notices were posted as required by law.

Approval of Agenda.

Motion by Schatzman to adopt the agenda as presented; seconded by Stanelle.

Motion prevailed by a voice vote (4-0).

- 4. Approval of Minutes:
 - a. June 17, 2025 meeting of the TB, UD1, SD4.

Motion by Stanelle to approve the minutes as presented; seconded by Kohlmann.

Motion prevailed by a voice vote (4-0).

- 5. Citizen Comments: Three-minute limit.
 - a. Residents from the Brookview Condominiums expressed concerns for the proposed golf simulator business.
 - b. Residents on S Allen Rd and Kossow Rd voiced their concerns regarding the property maintenance code enforcement.
- 6. Old Business: None.
- 7. New Business: None.
- 8. Departments, Boards, Committee/Commission Reports/Recommendations:
 - a. Plan Commission:
 - 1. Discussion and possible action regarding the request by Jordan Jackson, representing The Sandtrap LLC, to approve a conditional use permit for a golf simulator business in the B-2 Limited General Business District, located at 17800 West Bluemound Road.

Motion by Kohlmann to approve a conditional use permit for a golf simulator business in the B-2 Limited General Business District, located at 17800 West Bluemound Road with the following conditions:

- Phase I Only
- Hours of Operation: Monday Saturday 10 a.m. 10 p.m.; Sunday 10 a.m. 8 p.m.
- Roll Door: 12 p.m. Dusk

- Noise levels must not exceed residential level decibels at the property line.
- Review 6 months from issuance of the occupancy permit.

Seconded by Stanelle.

Motion prevailed by a voice vote (3-1).

2. Discussion and possible action regarding the request by Eric Nesseth, with Stephen Perry Smith Architects, for conceptual approval for a building addition to the MLG Capital Building, located at 19000 West Bluemound Road Suite A.

Motion By Schatzman to approve the request by Eric Nesseth, with Stephen Perry Smith Architects, for conceptual approval for a building addition to the MLG Capital Building, located at 19000 West Bluemound Road Suite A.; Seconded by Stanelle.

Motion prevailed by a voice vote (4-0).

 Discussion and possible action regarding the request by Erik Madisen, with Madisen Maher Architects representing KHS Group, for conceptual approval for proposed building expansions, located at 880 Bahcall Court. Motion by Stanelle to approve the request by Erik Madisen, with Madisen Maher Architects representing KHS Group, for conceptual approval for proposed building expansions, located at 880 Bahcall Court.; Seconded by Schatzman.

Motion prevailed by a voice vote (4-0).

- b. Clerk's Office:
 - 1. Memo Addressing Establishment Concerns Regarding Town Code Chapter 12.12 Massage Therapy Businesses and Massage Therapists.

<u>Howells and Hagie provided a breakdown of the memo referencing the AMTA – Wisconsin Chapter website which clarifies municipalities are able to enact ordinances for business regulation, and provided examples of other cities who have and enforce similar ordinances, including the City of Milwaukee.</u>

9. Approval of Vouchers and Checks.

Motion by Stanelle to approve vouchers and checks in the amount of \$129,627.04; seconded by Schatzman. Motion prevailed by a voice vote (3-0-1). Kohlmann voted present.

- 10. Communication and Announcements.
- 11. Adjourn.

Motion by Kohlmann to adjourn at 8:20 p.m.; seconded by Stanelle.

Motion prevailed by a voice vote (4-0)

Respectfully submitted by,

Emily Howells, Deputy Clerk

TOWN OF BROOKFIELD PLANNING COMMISSION RECOMMENDATIONS MAY 27, 2025

Town Chairman Henderson called the meeting to order at 7:13pm on Tuesday, May 27, 2025, at the Town of Brookfield Town Hall, 645 North Janacek Road, Brookfield, Wisconsin. Also present at the meeting was Town Supervisor Ryan Stanelle, Commissioners Dan Zuperku, Len Smeltzer, and Jeremy Watson and Town Planner Bryce Hembrook. Commissioners Tim Probst and Kevin Riordan were absent.

JIM TAYLOR (OSCAR'S) IS REQUESTING APPROVAL FOR A CONDITIONAL USE PERMIT FOR A NEW DRIVE-THRU RESTAURANT ON THE PROPERTY LOCATED AT 21165 HIGHWAY 18 AND PARKING ON PROPERTY TO THE EAST

Commissioner Watson moved to **recommend approval to the Town Board for a conditional use permit request** for a new drive-thru restaurant on the property located at 21165 Highway 18 and parking on property to the east subject to Town Engineer's approval, a certified survey map is recorded within 365 days of Town Board final approval, and the applicant shall submit a draft shared access and parking document to Town Board.

The motion was seconded by Supervisor Stanelle. The motion carried.

JIM TAYLOR (OSCAR'S) IS REQUESTING PRELIMINARY AND FINAL APPROVAL FOR A NEW DRIVE-THRU RESTAURANT ON THE PROPERTY LOCATED AT 21165 HIGHWAY 18 AND PARKING ON PROPERTY TO THE EAST

Commissioner Watson moved to grant preliminary and **recommend final approval to the Town Board for a conditional use permit amendment** for a new drive-thru restaurant on the property located at 21165 Highway 18 and parking on property to the east as presented.

The motion was seconded by Commissioner Smeltzer. The motion carried.

LINDSEY CHIAVEROTTI (WISCONSIN ADULT CENTER DBA BROOKFIELD ADULT CENTER) IS REQUESTING APPROVAL FOR A CONDITIONAL USE PERMIT AMENDMENT TO ALLOW THE EXPANSION OF AN ADULT DAY CARE CENTER IN THE B-3 OFFICE AND PROFESSIONAL BUSINESS DISTRICT, LOCATED AT 20711 WATERTOWN ROAD SUITE V

Commissioner Watson moved to **recommend the Town Board approve** a conditional use permit amendment to allow the expansion of an adult daycare center in the B-3 Office and Professional Business District for Wisconsin Adult Center DBA Brookfield Adult Center, located at 20711 Watertown Road Suite V as presented.

The motion was seconded by Supervisor Stanelle. The motion carried.

JORDAN JACKSON (THE SANDTRAP LLC) IS REQUESTING TO SET A PUBLIC HEARING DATE TO DISCUSS A CONDITIONAL USE PERMIT REQUEST FOR A GOLF SIMULATOR BUSINESS LOCATED AT 17800 WEST BLUEMOUND ROAD

Commissioner Watson moved to **recommend the Town Board set a date for a public hearing to discuss a conditional use permit request** for a golf simulator business located at 17800 West Bluemound Road.

The motion was seconded by Commissioner Zuperku. The motion carried.

RYAN JANSSEN (AVERY & BIRCH) IS REQUESTING FINAL APPROVAL OF A NEW BUILDING CONSISTING OF A ONE-STORY SALON SUITE FACILITY, LOCATED AT 21055 CROSSROADS CIRCLE

Commissioner Watson moved to **recommend** final approval to the Town Board for a new building consisting of a one-story salon suite facility, located at 21055 Crossroads Circle as presented.

The motion was seconded by Commissioner Smeltzer. The motion carried.

LUKE SEBALD (KELLER, INC), REPRESENTING BANCROFT ENGINEERING, IS REQUESTING PRELIMINARY AND FINAL APPROVAL FOR AN ADDITION TO AN EXISTING MANUFACTURING BUILDING, LOCATED AT 21550 DORAL ROAD

Commissioner Watson moved to **grant preliminary and recommend final approval** for an addition to an existing manufacturing building, located at 21550 Doral Road as presented.

The motion was seconded by Commissioner Zuperku. The motion carried.



Building a Better World for All of Us®

TOWN OF BROOKFIELD PLAN COMMISSION ZONING REPORT

TO: Plan Commission

FROM: Bryce Hembrook, AICP

Town Planner

REPORT DATE: May 22, 2025 PC MEETING DATE: May 27, 2025

RE: Avery & Birch – Final Approval

21055 Crossroads Circle BKFT1129999007

SEH No. 171421, TASK 93

Applicant: Ryan Janssen (Avery & Birch)

Application Type: Final Approval

Request

Final approval of a new building consisting of a one-story salon suite facility, located at 21055 Crossroads Circle.

Summary of Request

- Received approval for a three-story facility in 2024 but have since changed their plans. Applicant is now proposing a single-story 16,550 square foot building that will be used for luxury salon suite rentals.
- Each one of the suites is occupied by a self-employed beauty professional. Avery and Birch does not
 provide beauty services we simply act as a landlord for our multi-tenant buildings. This use for this
 submittal is similar to the last approval except for the proposed building is now a single-story building.
- Zoning District = B-2 Limited General Business District
- Currently a vacant 3.67 acre parcel in an office park.
 - This parcel has received two approvals in the past few years. First, Quest Interiors received final
 approval for their facility on the subject property in 2023, but decided to no longer pursue the
 project. Avery and Birch received final approval in 2024 but have since changed their plans.
- Proposed structure = 16,550 total square foot facility with salon suites.
- Approximately 86 parking stalls currently proposed, including 4 handicap stalls.
 - The proposed use is likely considered a personal service use, which requires one space per 200 square feet of gross floor area, plus one space per employee for the work shift with the largest number of employees.
 - According to the code, 82 parking spaces are required for the square footage and the number of employees is unknown at this time.
 - The proposed site plan shows one drive access to Crossroads Circle.
- Proposed setbacks:
 - o Front = 154'

- Side = 107' north and 101' south
- o Rear = 77'
- All building setbacks will meet code requirements.
- The pavement setbacks appear to meet requirements.
- Sum total of floor area
 - Proposed = 10.3% of lot area.
 - Required = No less than 6,000sf or 15% of the lot area, whichever is less. Shall not exceed 50% of lot area.
 - o Requirement is met.
- No building height dimensions were provided but the building will likely meet the 45' height requirement.
- There are single-family residences directly to the west of the subject property, but only one of the adjacent parcels is zoned residential. The applicant intends to keep the existing landscaping to serve as a buffer for the residential properties.

Development Review Team

The Development Review Team has reviewed this item and most items have been addressed.

Sanitary District No.4 Comments

- According to our records the existing water service in Crossroads Cir is 6", they are proposing connecting a 8" watermain to it. So the existing service will need to be abandoned and tap a new 8" tee and valve or the existing 8"x6" Tee be replaced by a 8"x8" Tee. Either way the watermain will need to be turned off to abandon the existing 6", the neighboring office buildings will need to be notified and this may need to be completed at night. The existing watermain is in the street so street restoration and traffic control should be added.
- The proposed 8" watermain and hydrant will become public, it should be noted and I believe a DNR approval will be needed.
- The "Hydrant Installation Figure 2" specifies a Ductile Iron Lead, we allow PVC.
- I would also like to know how close to the curb the hydrant will be located, if it's to close it may be difficult to access if there's a car parked and can be easily hit by snow plow.

Staff Recommendation


Per the discretion of the Plan Commission.

CONSTRUCTION PLANS

AVERY & BIRCH 21055 CROSSROADS CIRCLE TOWN OF BROOKFIELD, WISCONSIN

LEGEND

SECTION CORNER MONUMENT ————E———— UNDERGROUND ELECTRIC ——1008—— EXISTING CONTOUR ×¹⁰⁰⁸ PROPOSED SPOT ELEVATION ----1008----- PROPOSED CONTOUR PROPOSED DRAINAGE DIRECTION FOB SOIL TYPE
FG 1008.0 PROPOSED YARD GRADE

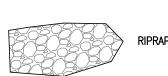


1) A LEGEND SHOWING SPECIAL SYMBOLS, LINE TYPES, ETC. IS SHOWN HERON. 2) UNDERGROUND UTILITIES MUST BE LOCATED BY "DIGGERS HOTLINE" PRIOR TO START OF

GENERAL NOTES:

1. BEARINGS ARE REFERENCED TO THE CERTIFIED SURVEY MAP NO. 6536, IN WHICH WEST LINE OF THE NE 1/4 OF SEC. 31-7-20 WAS TAKEN TO BEAR S02°06'31"W.

2. Vertical datum is based on North American Vertical Datum of 1988.


3. ALL SITE IMPROVEMENTS AND CONSTRUCTION SHOWN ON THE PLANS SHALL CONFORM TO THE CURRENT TOWN OF BROOKFIELD CONSTRUCTION STANDARDS. WHERE THE PLANS DO NOT COMPLY, IT SHALL BE THE SOLE RESPONSIBILITY AND EXPENSE OF THE DEVELOPER TO MAKE REVISIONS TO THE PLANS AND/OR CONSTRUCTED INFRASTRUCTURE TO COMPLY.

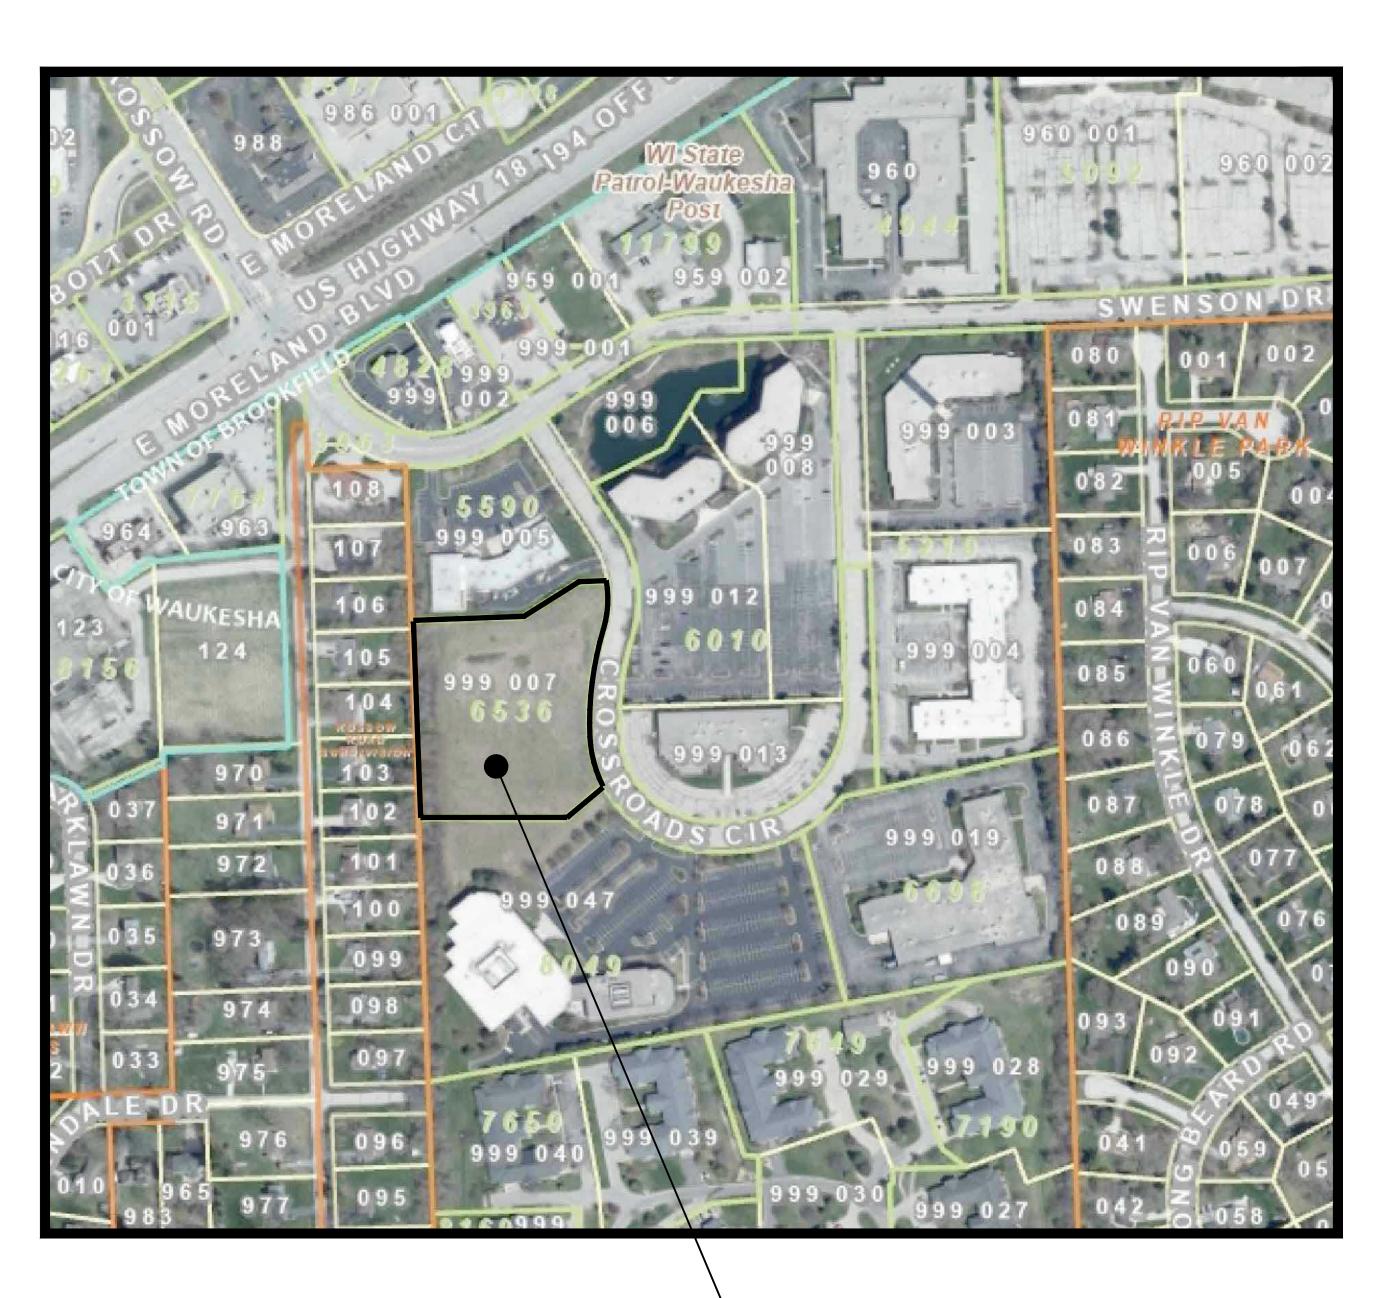

DEVELOPER: Ryan Janssen Ryan's Buying LLC 13416 Watertown Plank Rd. #245 Elm Grove, WI 53122 Phone: 414-736-3066 Email: ryan@ryansbuying.com ENGINEER: Mark R. Ellena, PE Ellena Engineering Consultants, LLC 700 Pilgrim Parkway, Suite 100 Elm Grove, WI 53122 Phone: 262-791-6183 Email: mellena@eeceng.com SURVEYOR: TBD APPROVAL AGENCY: Town of Brookfield SCALE: 1" = 200'

SUBJECT PROPERTY

DESCRIPTION SHEET NO. SITE PLAN GRADING, PAVING & DRAINAGE PLAN UTILITY PLAN **EROSION CONTROL PLAN** C400 **DETAILS** C500 - C501

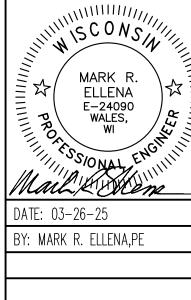

SHEET NUMBER C000



LLC © BIR TOWN IIIIIIS CONSIA. MARK R. ELLENA E-24090 WALES, WI Mail Man DATE: 03-26-25 BY: MARK R. ELLENA,PE SCALE: 1"=30' SHEET NUMBER

C100


GENERAL CONSTRUCTION SPECIFICATIONS:

- 1. All work shall be in accordance with the Standard Specifications for Highway and Structure Construction, State of Wisconsin, Latest Edition; and the Town of Brookfield. All
- permits must be obtain by the contractor prior to commencing work.

 2. All erosion control measures specified on this plan shall meet the design criteria, standards and specifications as set forth by the Town of Brookfield and the Department of Natural Resources Wisconsin Technical Standards.
- 3. All erosion control devices (i.e., silt fence, gravel entrance, etc.) shall be installed prior to commencing construction.
- 4. All activities on the site shall be conducted in a logical sequence to minimize the area of bare soil exposed at any one time.
- 5. The owner shall provide all surveying and construction staking for this contract. All contractors shall exercise care and diligence in protecting the same.
- 6. The contractor shall notify Diggers Hotline, the local municipality and all government agencies that may be affected by the contractor's operations at least three (3) days before breaking ground.
- 7. Public roads shall not be closed to traffic at any time. All ingress and egress traffic to the project shall be limited to the gravel entrance to the property.
- 8. Contractor shall be responsible for maintaining the public streets. Public Streets shall be kept free of silt or dirt tracked from areas under construction by sweeping within 24hrs. Dust generated by construction activities shall be minimized by use of watering or other
- 9. Upon completion of the work as specified, respread four (4") inches of salvaged topsoil over all disturbed open space areas outside of the proposed roadway and provide seed,
- fertilizer and mulch per the Standard Specifications. 10. All disturbed areas shall be re-vegatated within seven days of no disturbance. Highway mix #40 shall be used for seeding with an application rate of 4.0 lbs/1000 sf.


GENERAL SPECIFICATIONS FOR PRIVATE STORM SEWER:

- 1. All work shall be in accordance with the Standard Specifications for Highway and Structure Construction, State of Wisconsin, Latest Edition, and the Town Ordinances and the State of Wisconsin Standard Specifications for Sewer and Water Construction in
- 2. The private storm sewer design, permitting, construction, installation, supervision, maintenance, inspection AND testing shall be in accordance with the Town of Brookfield Plumbing Inspection Department and the State of Wisconsin, Chapter SPS 382.. All permits must be obtain by the contractor prior to commencing work.
- 3. Private Storm Sewers shall be PVC (solid wall), DR-26 OR HDPE, per the State of Wisconsin Plumbing Code, Chapter SPS 382. Catch Basins and Inlets shall be precast concrete structures in accordance with the Standard Specifications for Sewer & Water Construction in Wisconsin (SEE DETAIL PLAN SHEET).

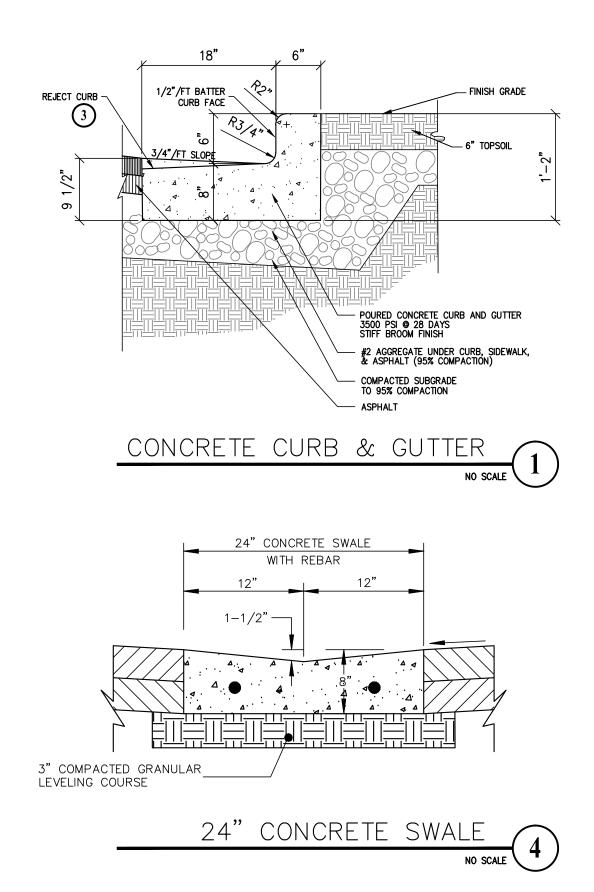

NOTE: ALL UNDERGROUND CONTRACTOR ARE REQUIRED TO FIELD LOCATE EXISTING UTILITIES, STORM SIZE & INVERT PRIOR TO CONSTRUCTION. OBTAIN ALL TOWN OF BROOKFIELD PERMITS PRIOR TO CONSTRUCTION.

THE BOUNDARY & TOPOGRAPHIC SURVEY WAS PROED BY EXCEL ENGINEERING. WHILE THIS INFORMATION IS BELIEVED TO BE RELIABLE, ITS ACCURACY AND COMPLETENESS CANNOT BE GUARANTEED NOR CERTIFIED TO.

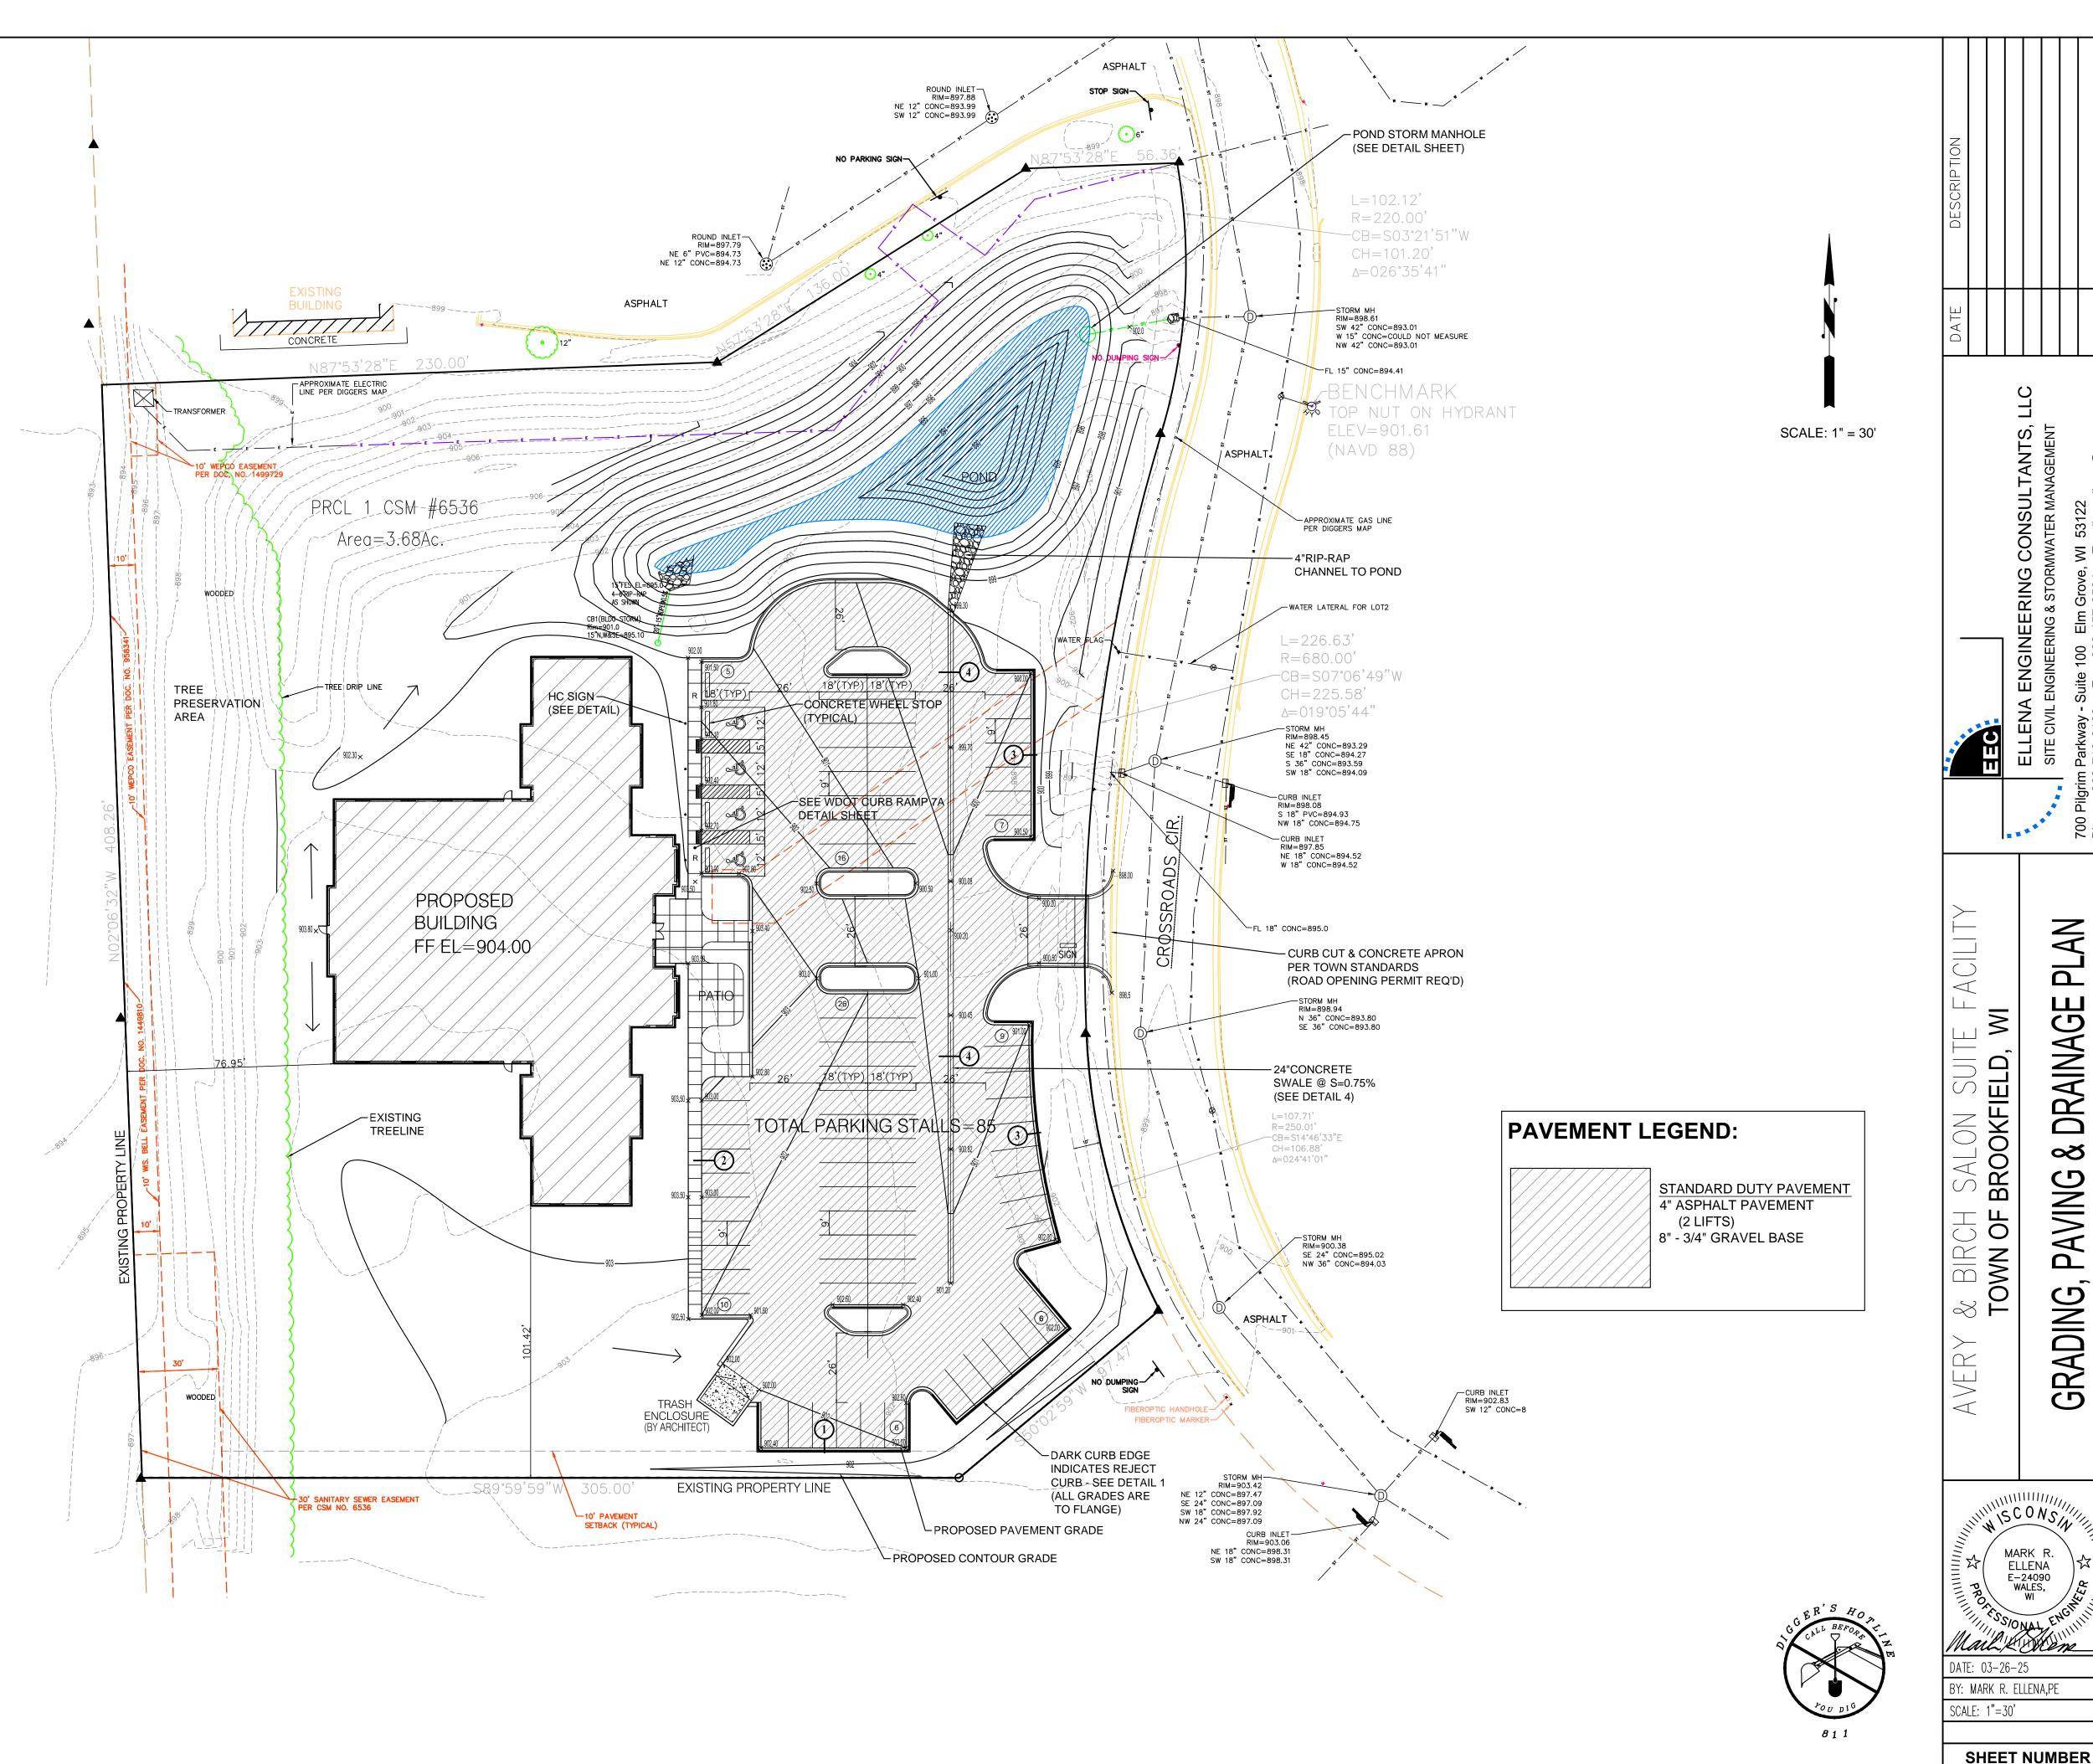

 \circ

Ω, F

ERING

ENGINE

Q

 \triangleleft

A

 Δ


AVIN


RADIN

ELLENA E-24090 WALES, WI

C200

NOTE: THIS GRADING PLAN MUST BE APPROVED BY THE TOWN ENGINEER AND BUILDING INSPECTOR

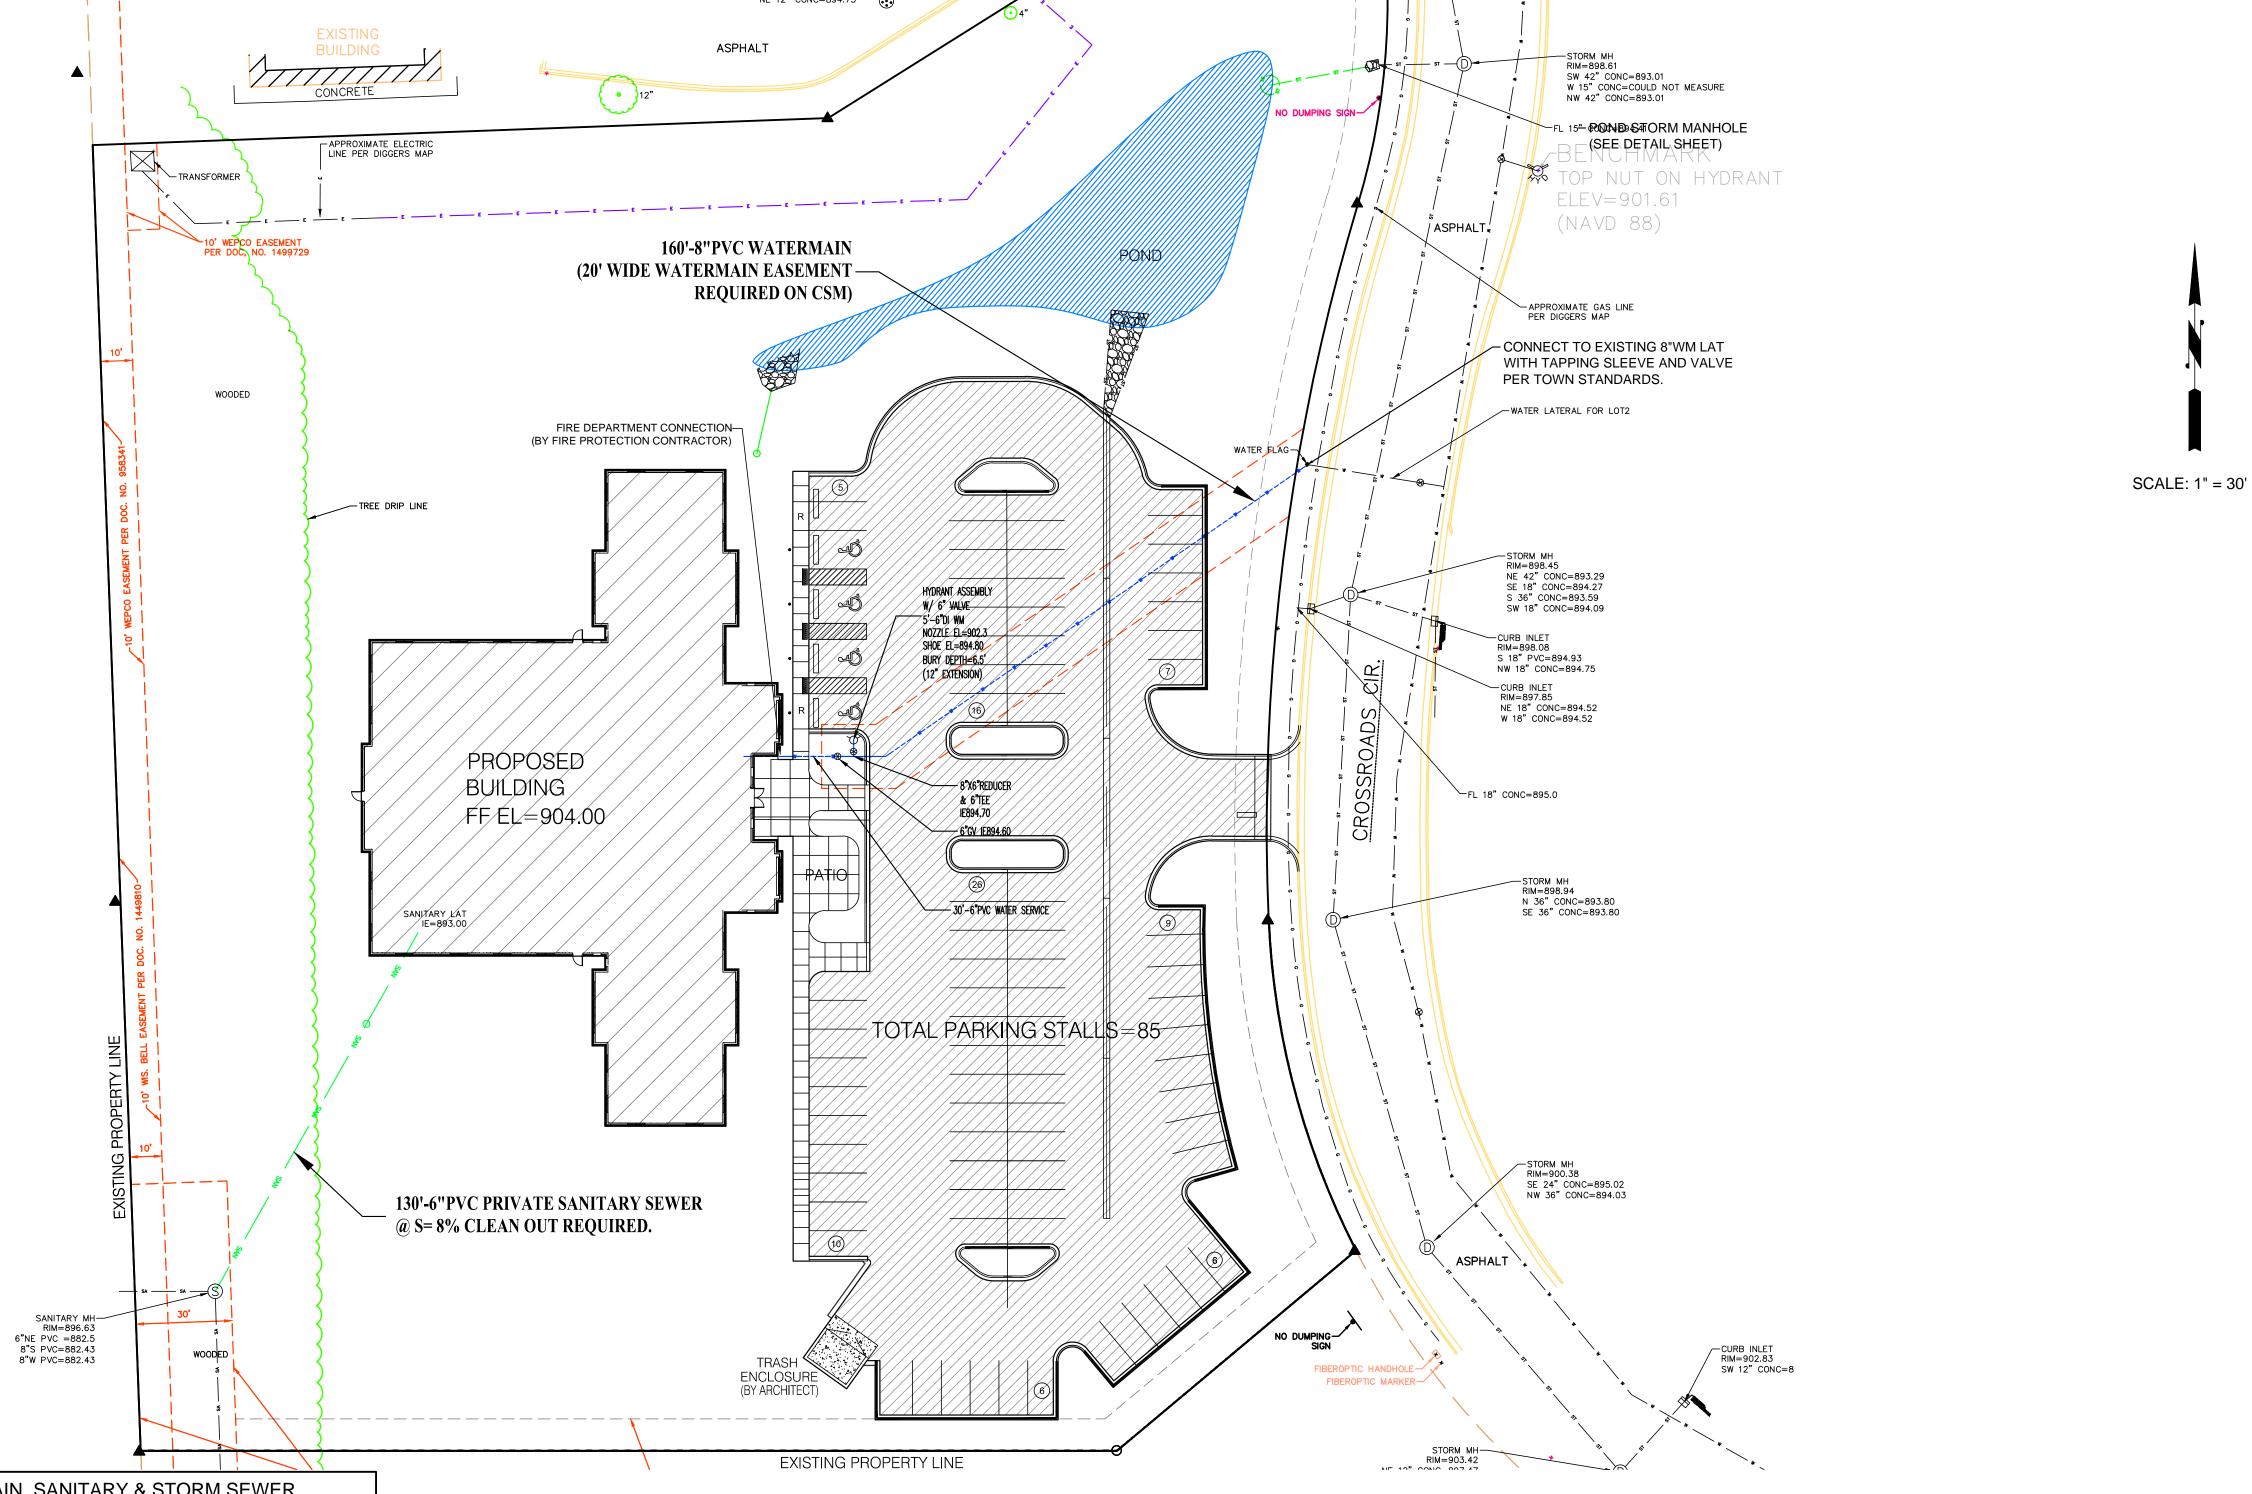

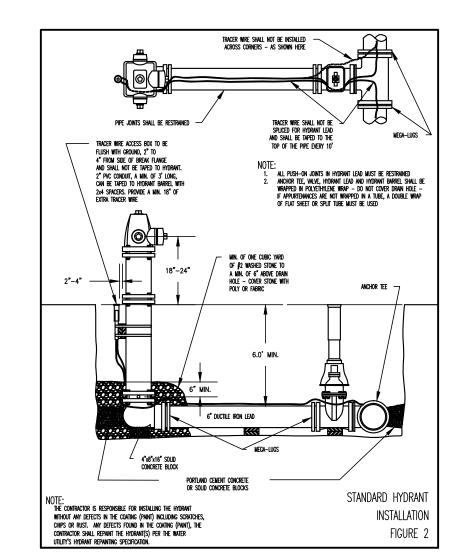

THE BOUNDARY & TOPOGRAPHIC SURVEY WAS PROED BY EXCEL ENGINEERING. WHILE THIS INFORMATION IS BELIEVED TO BE RELIABLE, ITS ACCURACY AND COMPLETENESS CANNOT BE GUARANTEED NOR CERTIFIED TO.

PRIVATE WATER MAIN, SANITARY & STORM SEWER

SPECIFICATIONS:

. All work shall be in accordance with the Standard Specifications for Highway and Structure Construction, State of Wisconsin, Latest Edition; the State of Wisconsin Standard Specifications for Sewer and Water Construction in Wisconsin, the State of Wisconsin Department of Safety and Professional Services Plumbing Code; and the Town Ordinances. TRACER WIRE REQUIRED ON ALL MAINS.

2. The private water main, sanitary & storm sewer design, permitting, construction, installation, supervision, maintenance, inspection AND testing shall be in accordance with State of Wisconsin, Chapter SPS 382. All permits must be obtain by the contractor prior to commencing work.

3. Private sanitary laterals shall be PVC (solid wall), ASTM D-3034, DR-35 or 28; or PVC (solid wall), AWWA C-900 per the State of Wisconsin Plumbing Code, Chapter SPS 382 and the Standard Specifications for Sewer & Water Construction in Wisconsin.

4. Private Water main laterals shall be PVC (solid wall), AWWA C-900, CLASS 235, DR-18 with Push-On type integral elastomeric bell-spigot joints per the State of Wisconsin Plumbing Code, Chapter SPS 382 AND the Standard Specifications for Sewer & Water Construction in Wisconsin. 6' BURY REQUIRED.

5. MINIMUM BURY DEPTH IS 6.5 FEET ACCORDING TO SECTION 12.4 OF THE TOWN TECHNICAL SPECIFICATIONS.


6. THE CONTRACTOR SHALL NOTIFY THE TOWN SANITARY DISTRICT NO. 4 AND FIELD STAFF A MINIMUM OF 72 HOURS BEFORE THE START OF ANY CONSTRUCTION OR CONNECTION TO EXISTING PUBLIC UTILITIES.

7. BUILDING PLUMBER TO PROVIDE SANITARY & WATER MAIN LATERAL SIZING CALCULATIONS FOR ISSUANCE OF BUILDING PERMIT.

GENERAL CONSTRUCTION SPECIFICATIONS:

- 1. All work shall be in accordance with the Standard Specifications for Highway and Structure Construction, State of Wisconsin, Latest Edition; and the Town of Brookfield. All permits must be obtain by the contractor prior to commencing work.
- 2. All erosion control measures specified on this plan shall meet the design criteria, standards and specifications as set forth by the Town of Brookfield and the Department of Natural Resources Wisconsin Technical Standards.
- All erosion control devices (i.e., silt fence, gravel entrance, etc.) shall be installed prior to commencing construction. All activities on the site shall be conducted in a logical sequence to minimize the area of bare soil exposed at any one time.
- The owner shall provide all surveying and construction staking for this contract. All contractors shall exercise care and diligence in protecting the same. 6. The contractor shall notify Diggers Hotline, the local municipality and all government agencies that may be affected by the
- contractor's operations at least three (3) days before breaking ground. 7. Public roads shall not be closed to traffic at any time. All ingress and egress traffic to the project shall be limited to the
- gravel entrance to the property. 8. Contractor shall be responsible for maintaining the public streets. Public Streets shall be kept free of silt or dirt tracked from areas under construction by sweeping within 24hrs. Dust generated by construction activities shall be minimized by use of watering or other appropriate methods.
- 9. Upon completion of the work as specified, respread four (4") inches of salvaged topsoil over all disturbed open space areas outside of the proposed roadway and provide seed, fertilizer and mulch per the Standard Specifications.
- 10. All disturbed areas shall be re-vegatated within seven days of no disturbance. Highway mix #40 shall be used for seeding with an application rate of 4.0 lbs/1000 sf.



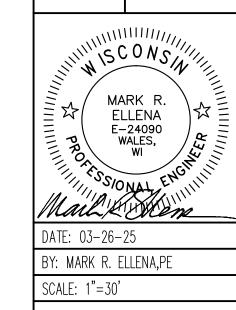

 \circ

ENGINE

 \leq

 \mathbb{R}


 Δ \ll


S


RIW.


BROOM

SHEET NUMBER C300

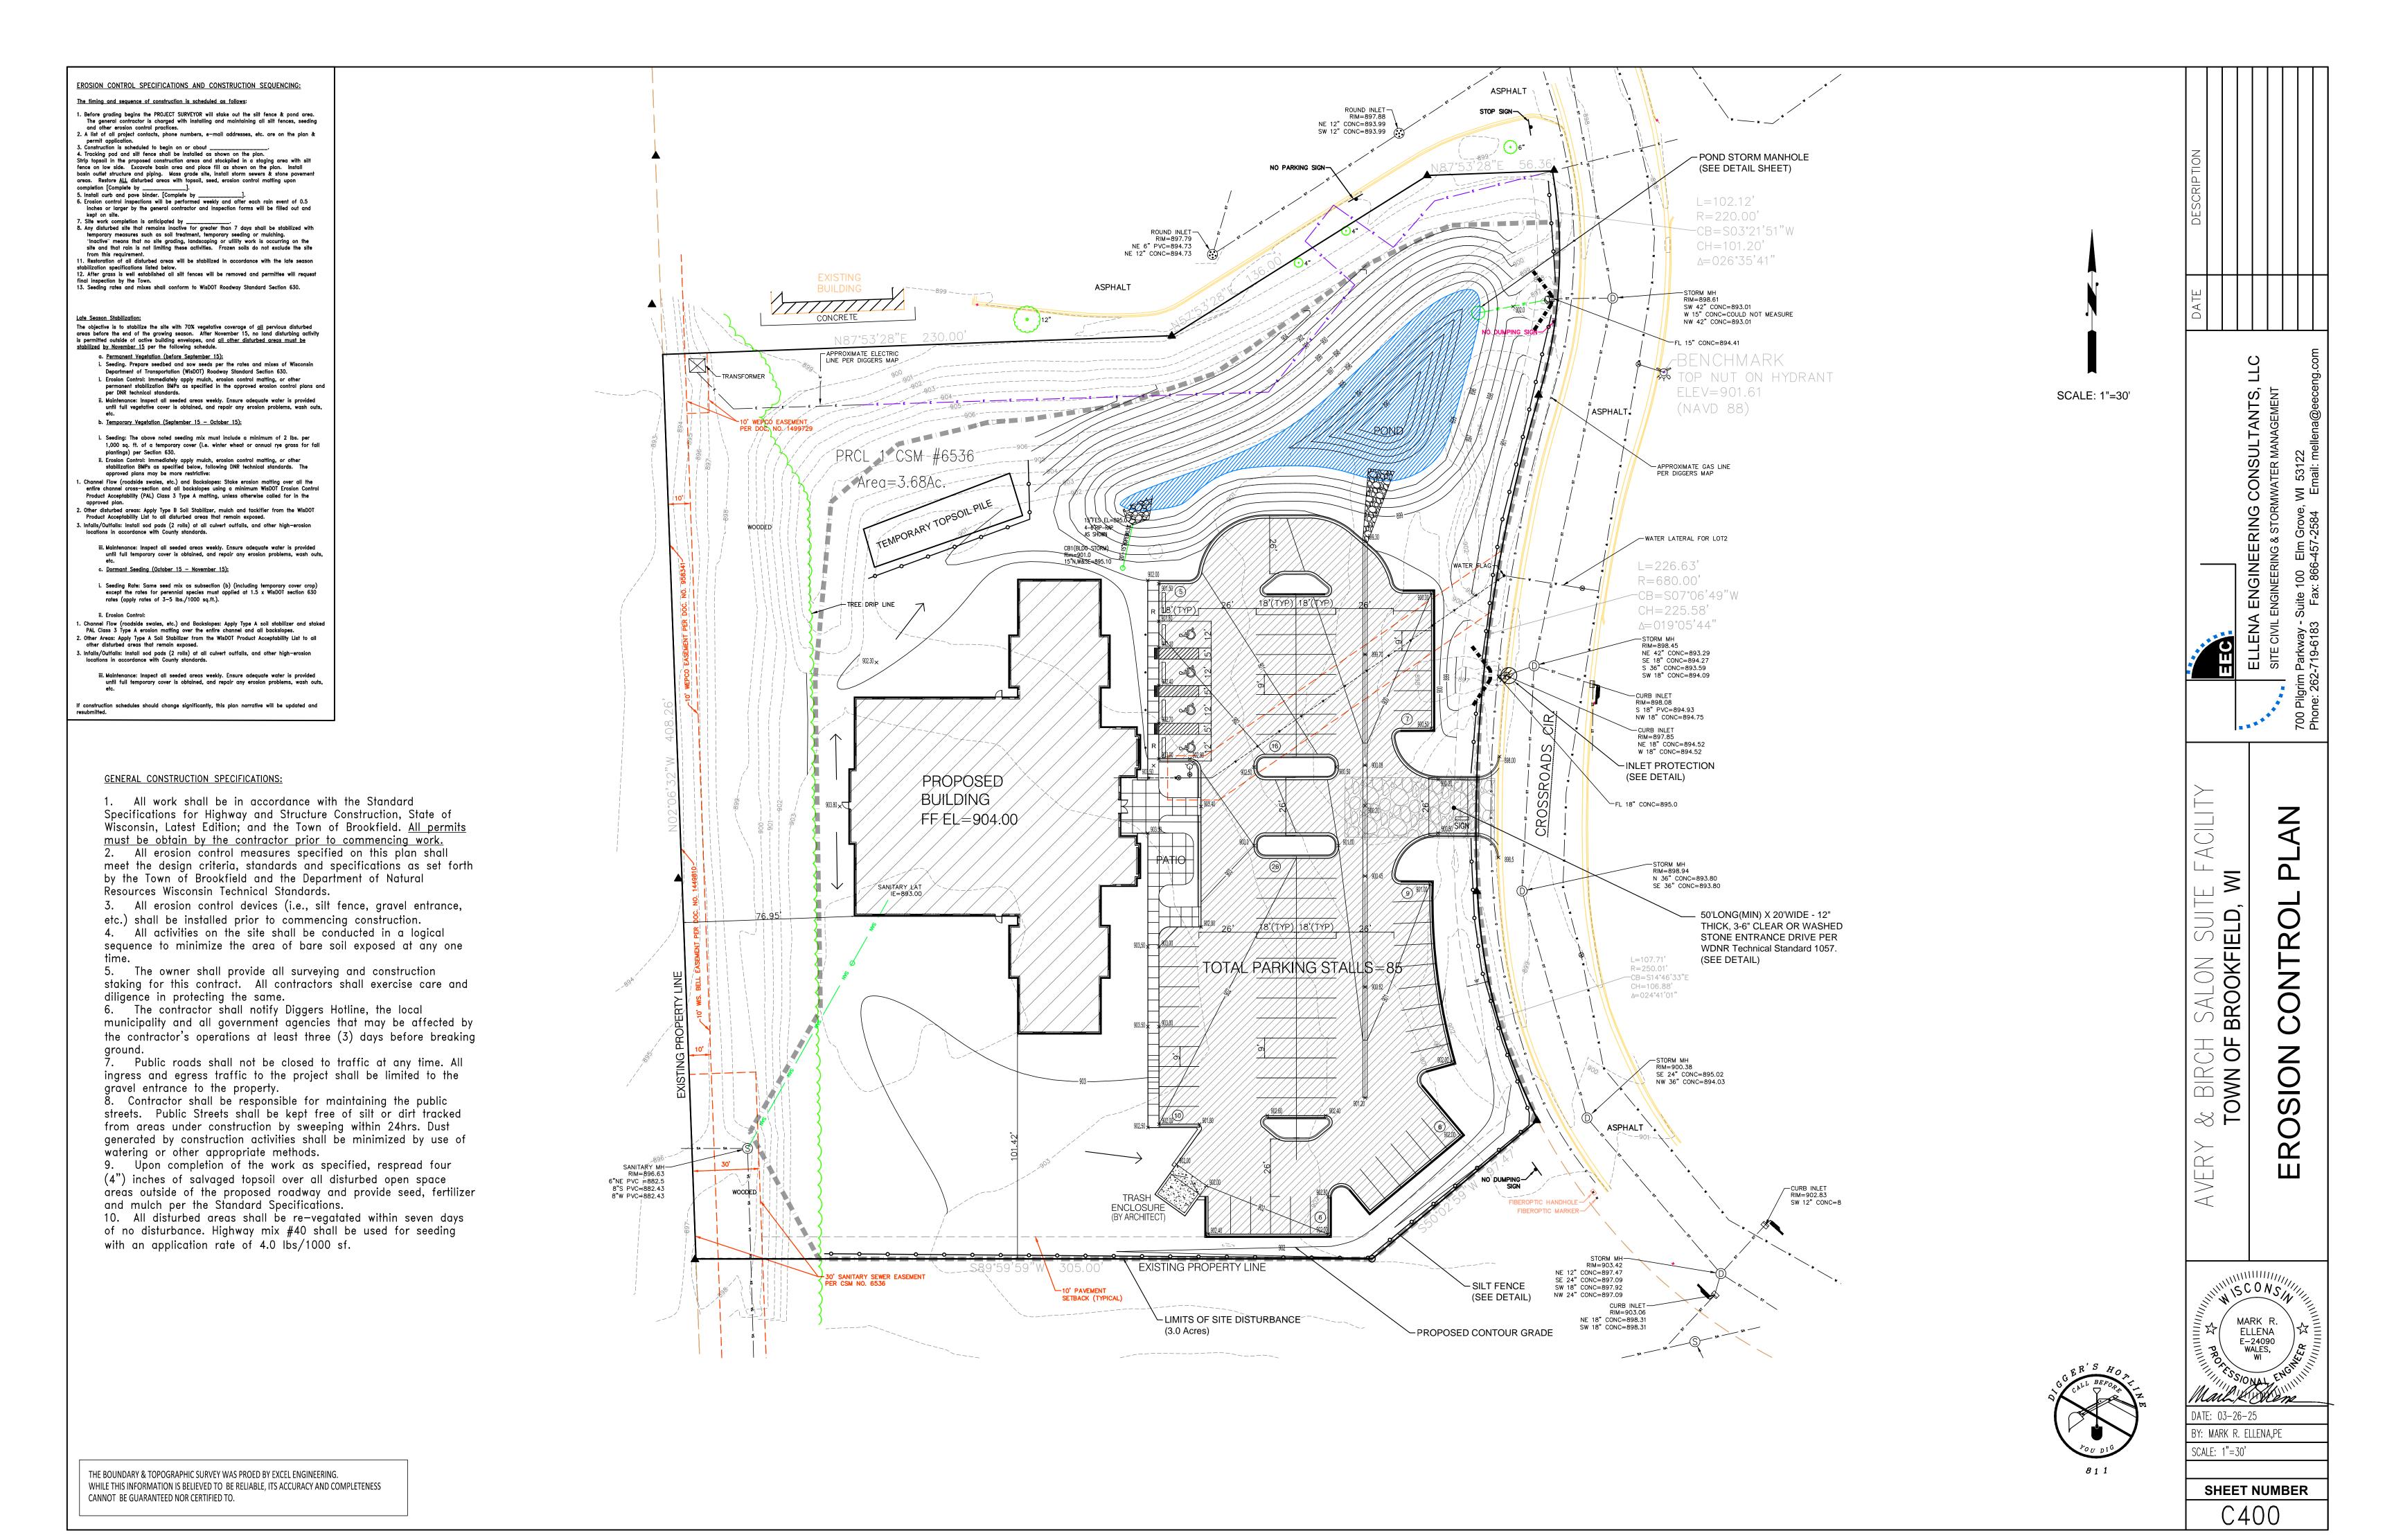

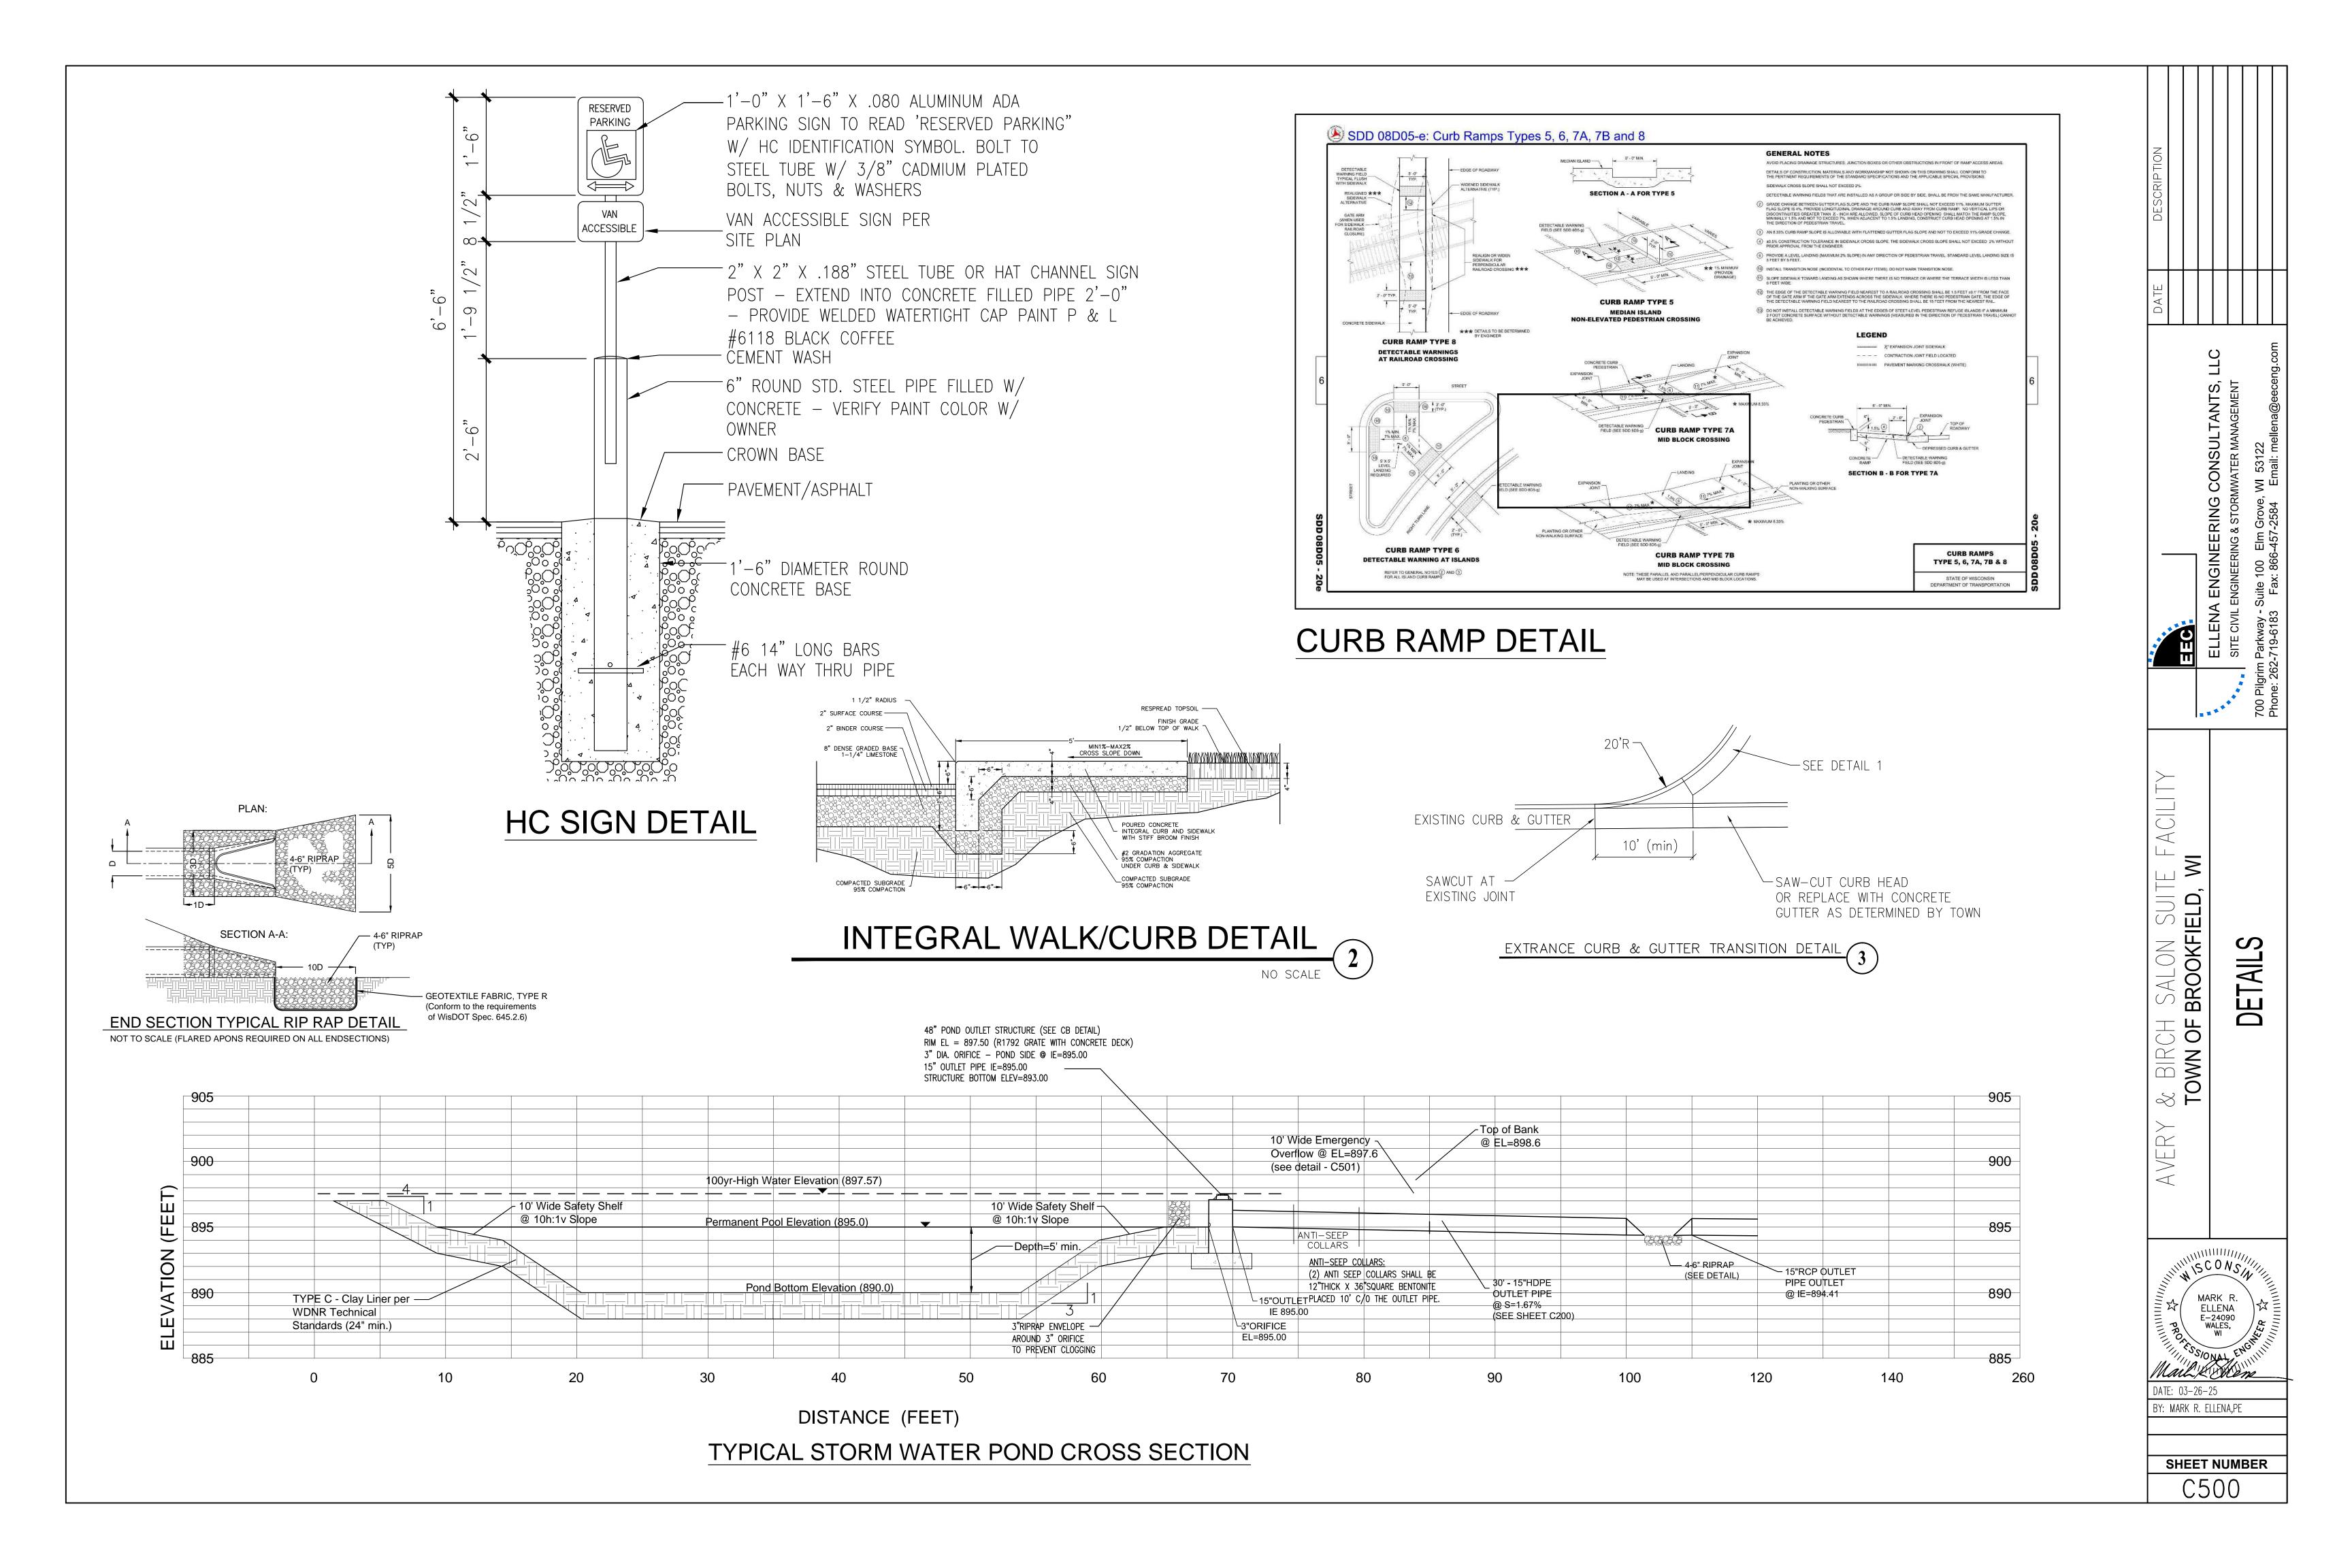

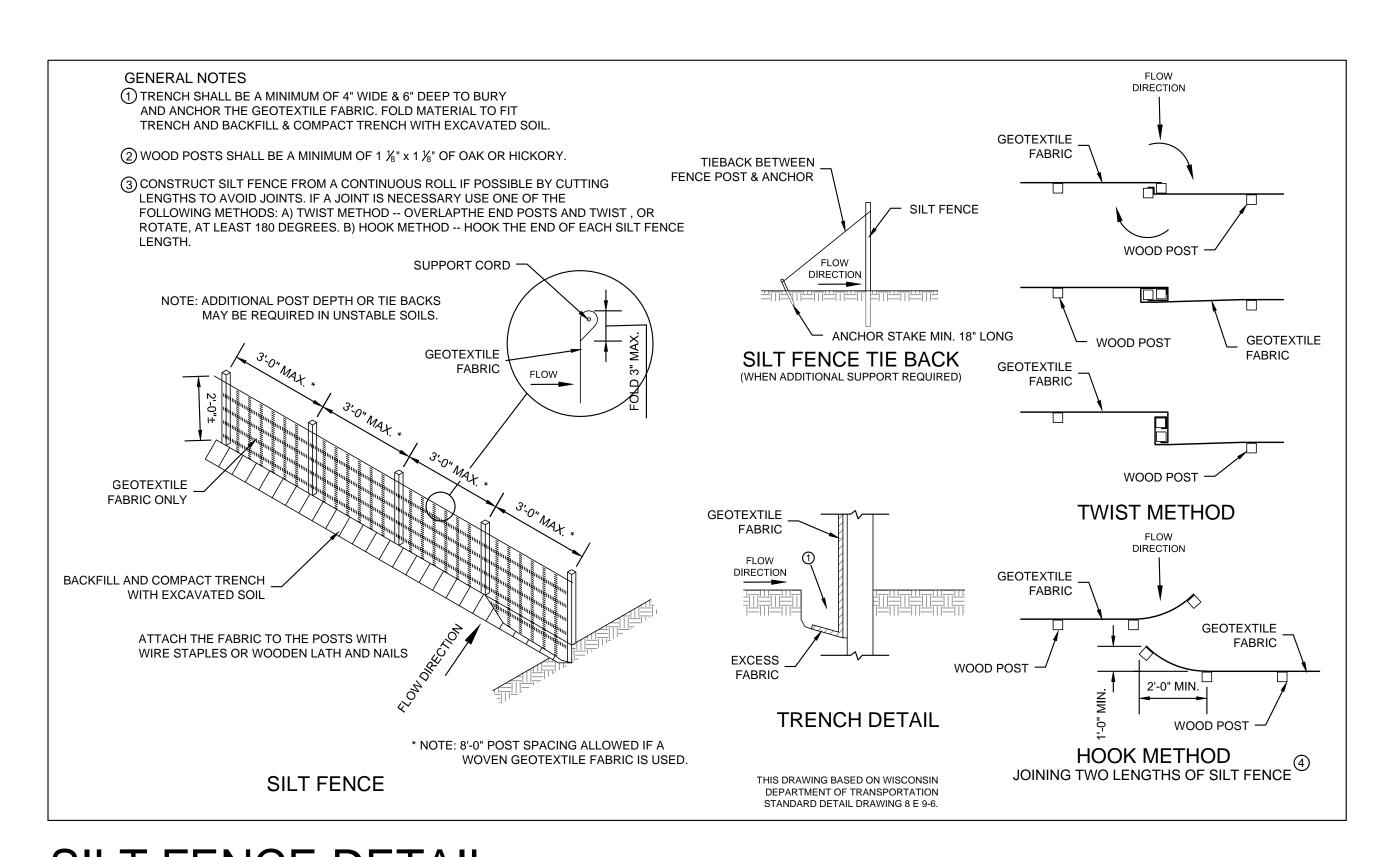

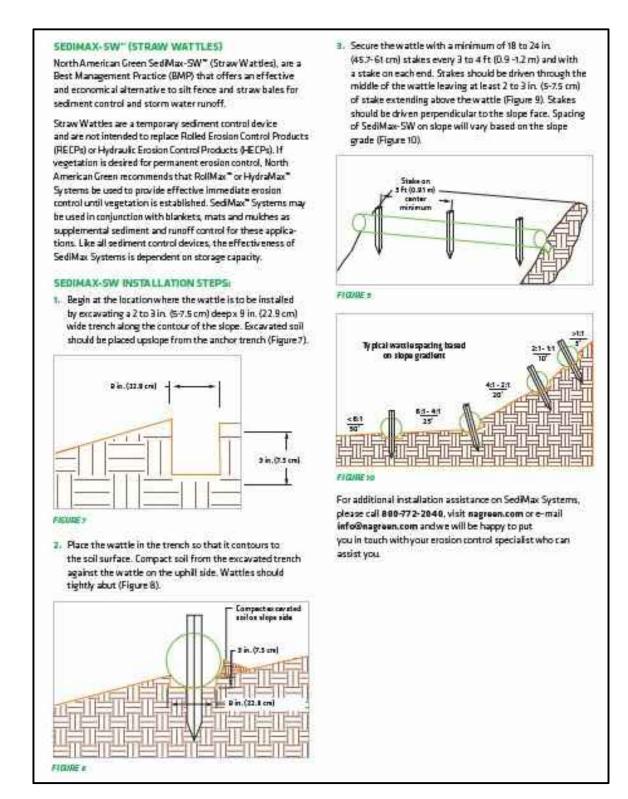

STRAW WATTLE DETAIL

STANDARD FLAT TOP SLAB SECTION (HEIGHT TO BE DETERMINED BY SUPPLIER) WITH 27" OFFSET ACCESS HOLE PRECAST CONC. M.H. SEGMENTS. SEAL ALL JOINTS WATERTIGHT MONOLITHIC PRECAST CONCRETE BASE SECTION 6" No. 1 STONE UNDISTURBED EARTH

NEENAH FOUNDRY OR -EQ. R-3067 CAST IRON

AGGREGATE BASE PER -

PAVEMENT SECTION

6" No. 1 STONE -UNDISTURBED EARTH -

FRAME & GRATE

ADJUST TO GRADE WITH PRECAST CONCRETE

EXTENSION RINGS, APPLY MORTAR IN JOINTS

PROVIDE COPOLYMER PROPYLENE PLASTIC STEPS M.A.

NEENAH FOUNDRY OR EQ. LOW PROFILE

- ADJUST TO GRADE WITH PRECAST

MORTAR IN JOINTS

WATERTIGHT JOINT PER

5' OR GREATER IN DEPTH.

VERIFIED WITH THE SUPPLIER

SHALL CONFORM TO ASTM C-478

ASTM C-443

CONCRETE EXTENSION RINGS, APPLY

R-1792-GG. R-3067 IN CURB & GUTTER

PROVIDE COPOLYMER PROPYLENE PLASTIC STEPS M.A. IND. INC. MODEL PS-2-PF-S (ASTM C-478) OR EQUAL AT A MAXIMUM

OF 16" O.C. IN ALL STORM STRUCTURES

NOTE: CONCRETE AND STEEL REINFORCEMENT

IND. INC. MODEL PS-2-PF-S (ASTM C-478) OR

EQUAL AT A MAXIMUM OF 16" O.C. IN ALL STORM


STRUCTURES 5' OR GREATER IN DEPTH.

NOTE: FINAL STRUCTURE SIZES TO BE VERIFIED WITH THE SUPPLIER

STORM CURB INLET (CI) DETAIL
NO SCALE

PRECAST CONC. M.H. SEGMENTS.


SEAL ALL JOINTS WATERTIGHT

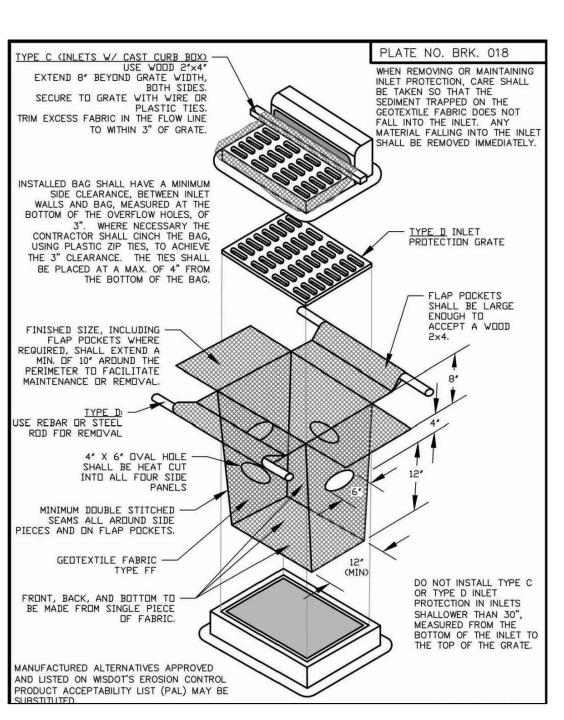

STORM CATCH BASIN (CB) W/ SUMP DETAIL

INLET PROTECTION

SILT FENCE DETAIL

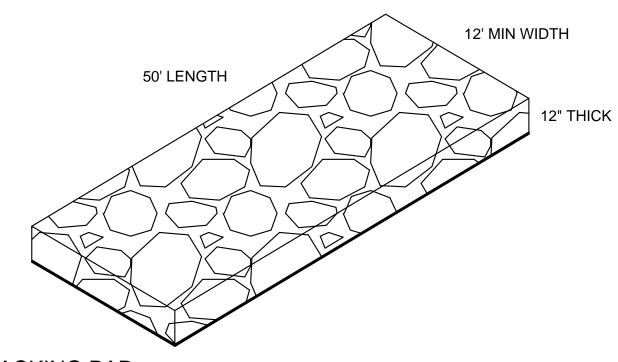

STONE TRACKING PAD

PER WDNR TECH STANDARD 1057


Note 1: Use hard, durable, angular No. 3" stone or recycled concrete meeting the gradation in Wisconsin Department of Transportation (DOT) 2018 Standard Specification, Section 312, Select Crushed Material.


Note 2: Slope the stone tracking pad in a manner to direct runoff to an approved treatment practice.

Note 3: Select fabric type based on soil conditions and vehicles loading.


Note 4: Install tracking pad across full width of the access point, or restrict existing traffic to a dedicated egress lane at least 12 feet wide across the top of the pad.

Note 5: If a 50' pad length is not possible due to site geometry, install the maximum length practicable and supplement with additional practices as needed.

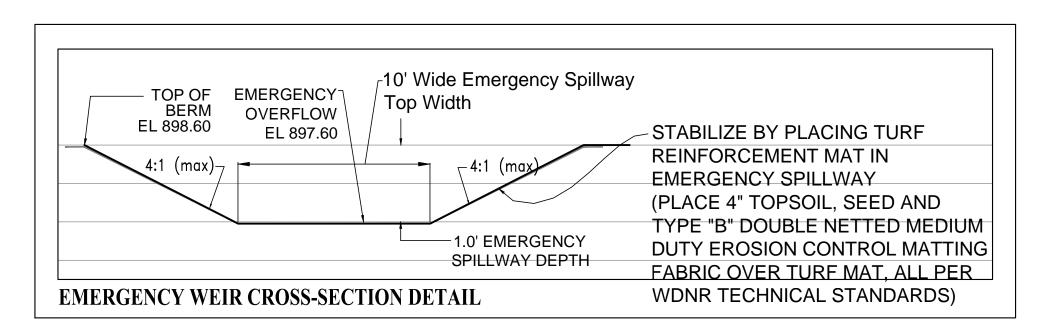

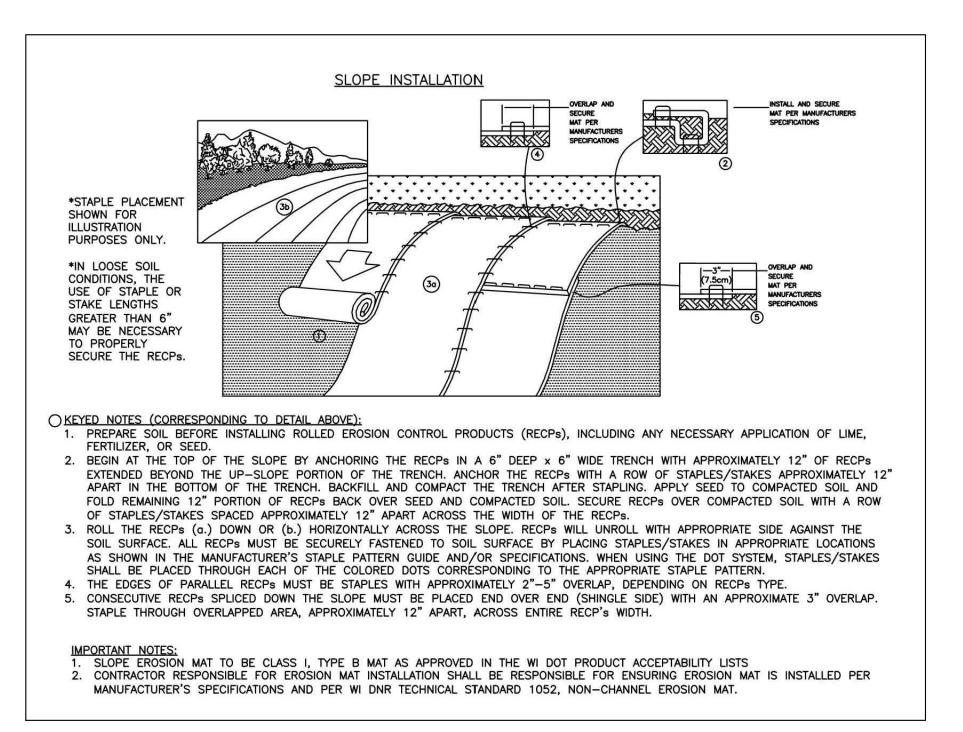


EROSION MATTING: WDNR TS-1052

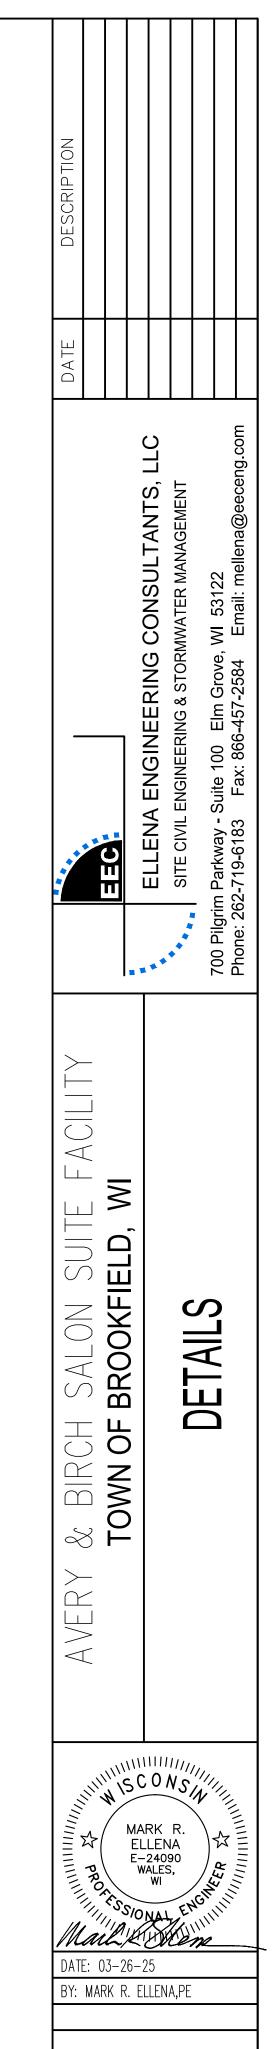



SHEET NUMBER







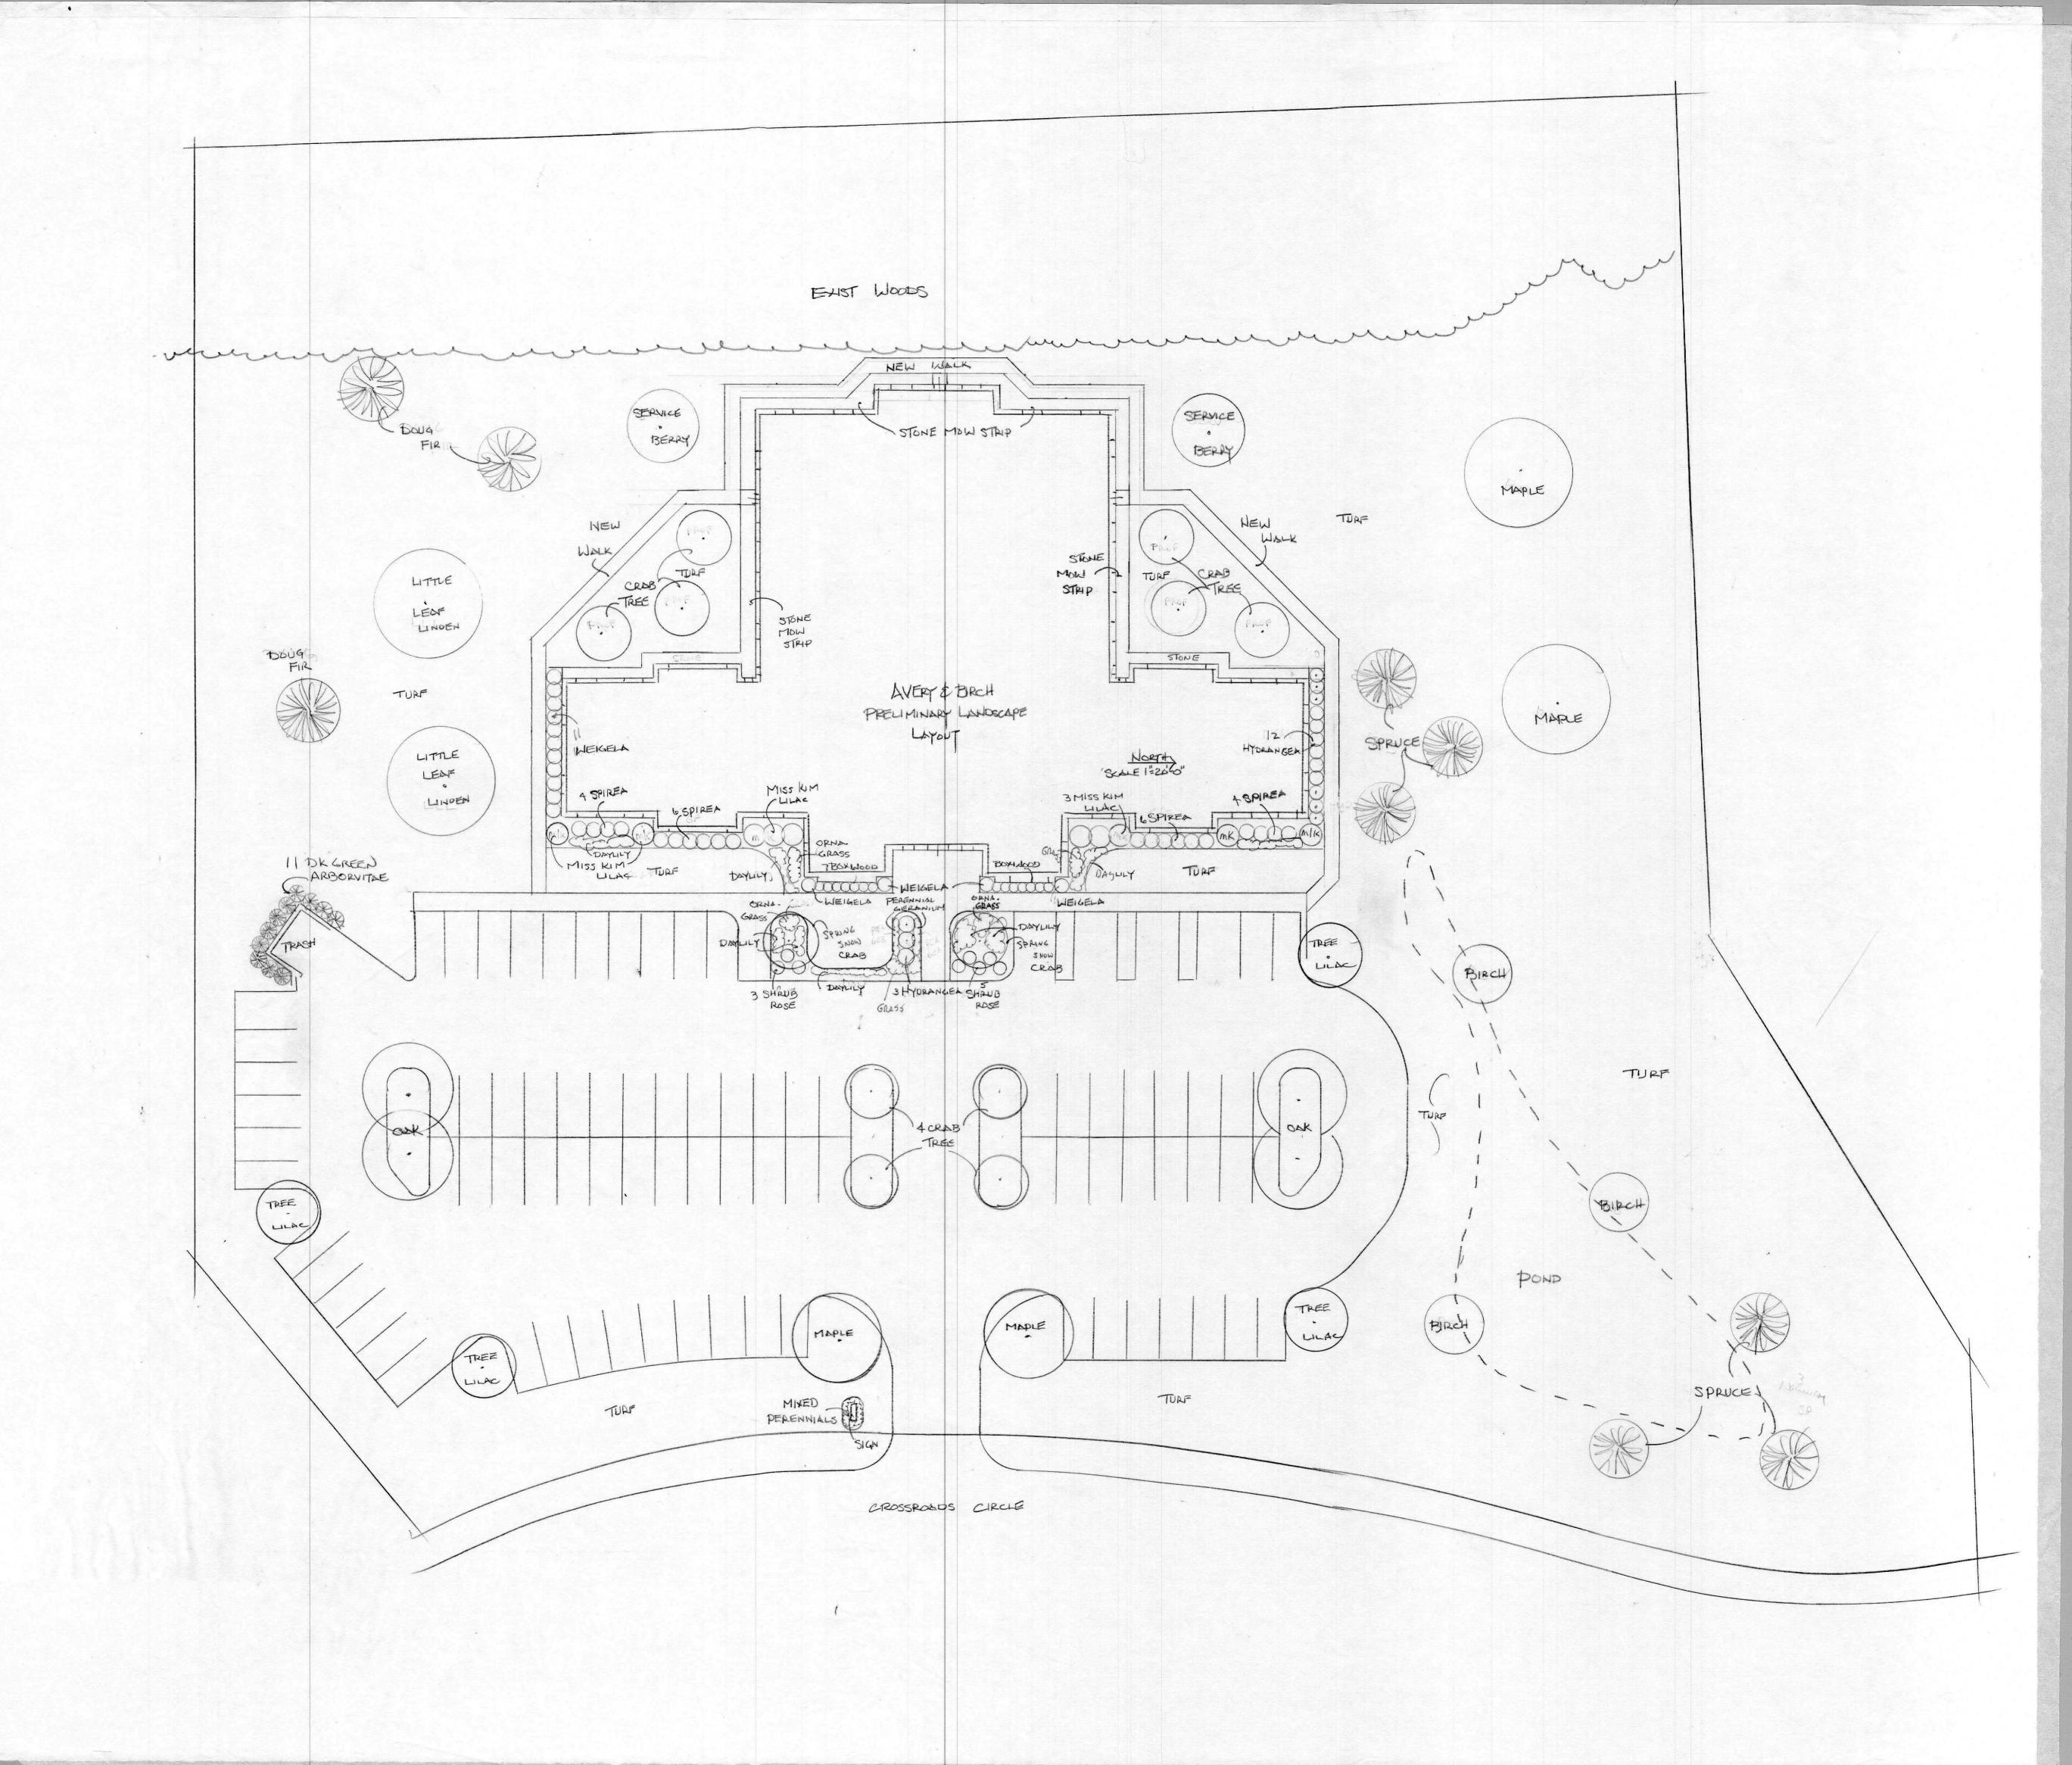

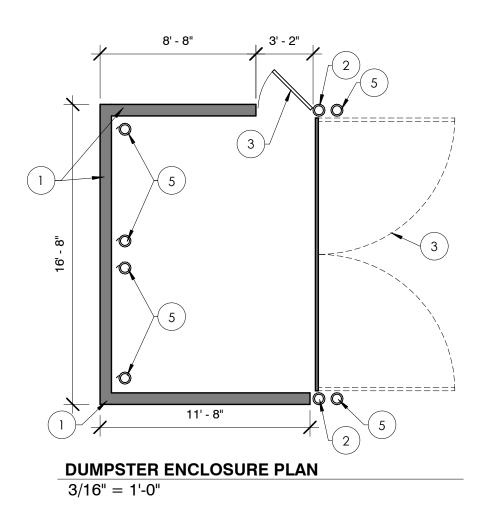


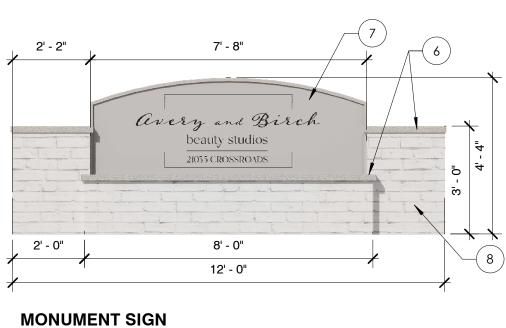


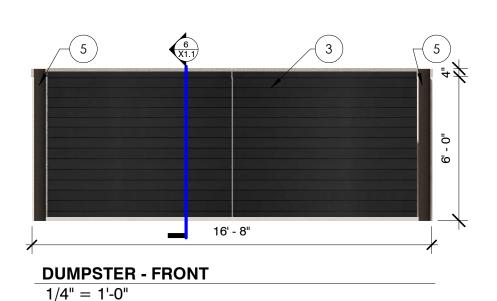

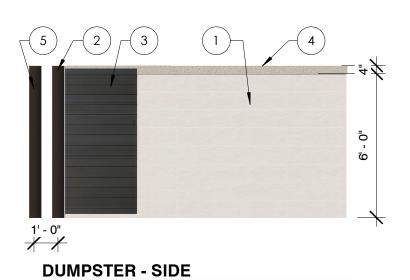

1/4" = 1'-0"

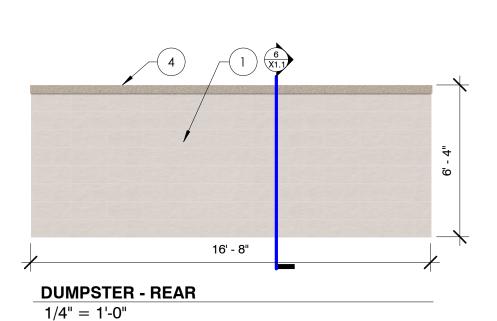


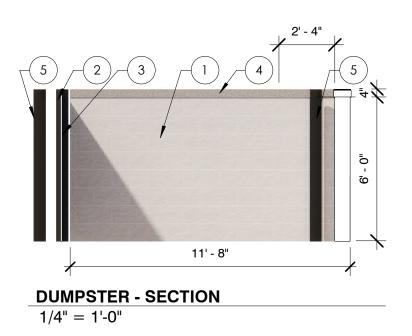

	KEYED GARBAGE ENCLOSURE AND SIGNAGE NOTES
TAG#	DESCRIPTION
1	8"X16" SPLIT FACE BLOCK (CMU-1), COLOR TO MATCH BRICK
2	6" CONCRETE FILLED GALVANIZED STEEL PIPE POSTS FOR GATE SUPPORT. SET 1" INSIDE EDGE OF CMU WALL
3	ENCLOSURE GATE/DOOR COMPOSITE DECKING (COLOR TO MATCH DARK BUILDING ACCENTS) ON PAINTED STEEL DOOR FRAME. PROVIDE DOOR HINGES, LATCHS, AND OTHER REQUIRED HARDWARE, TYP.
4	4" LIMESTONE CAP
5	6" CONCRETE FILLED GALVANIZED STEEL BOLLARD. 6'-4" TALL OUTSIDE OF ENCLOSURE, 4'-0" TALL INSIDE OF ENCLOSURE
6	2" LIMESTONE CAP
7	PREFINISHED METAL SIGN BOX
8	MASONRY BASE (BK-1), MATCH BRICK TO BUILDING

3/8" = 1'-0"



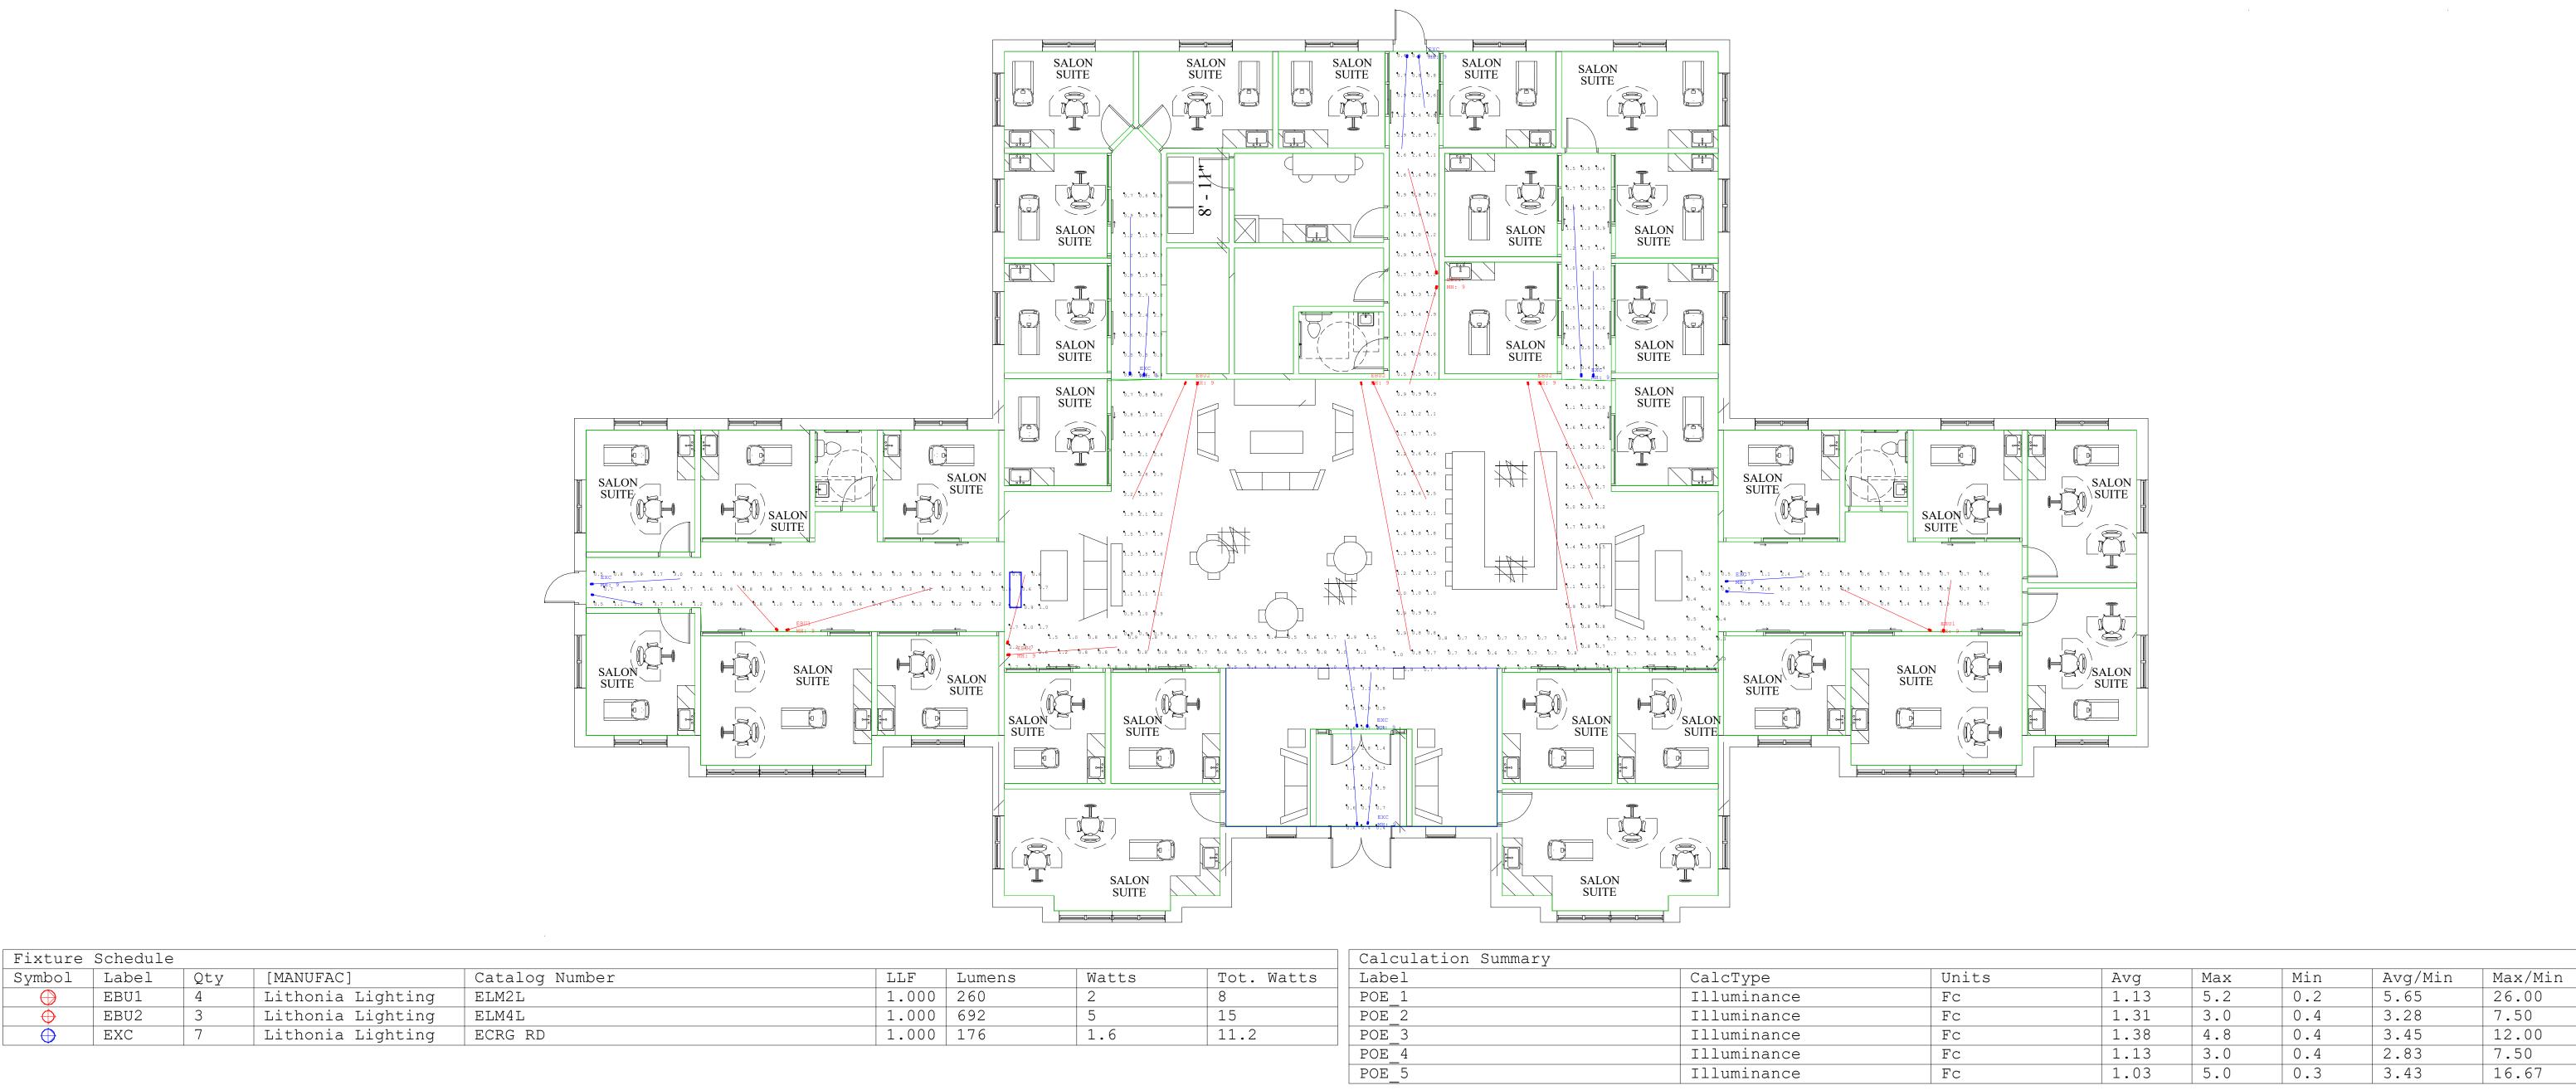


= LED Exit sign not factored into light levels

- 1. Standard Reflectance of 80/50/20 unless noted otherwise

- Not a Construction Document, for Design purposes only
 Standard indoor calc points @ 30" A.F.F. unless noted otherwise
 Standard outdoor calc points @ Grade unless noted otherwise
 CED Pewaukee assumes no responsibility for installed light levels due to field conditions, etc.

Revisions QUOTE# Drawn By: Nick Rooyak Date:4/3/2025 Birch \geq **∞** Avery

Page 1 of 1

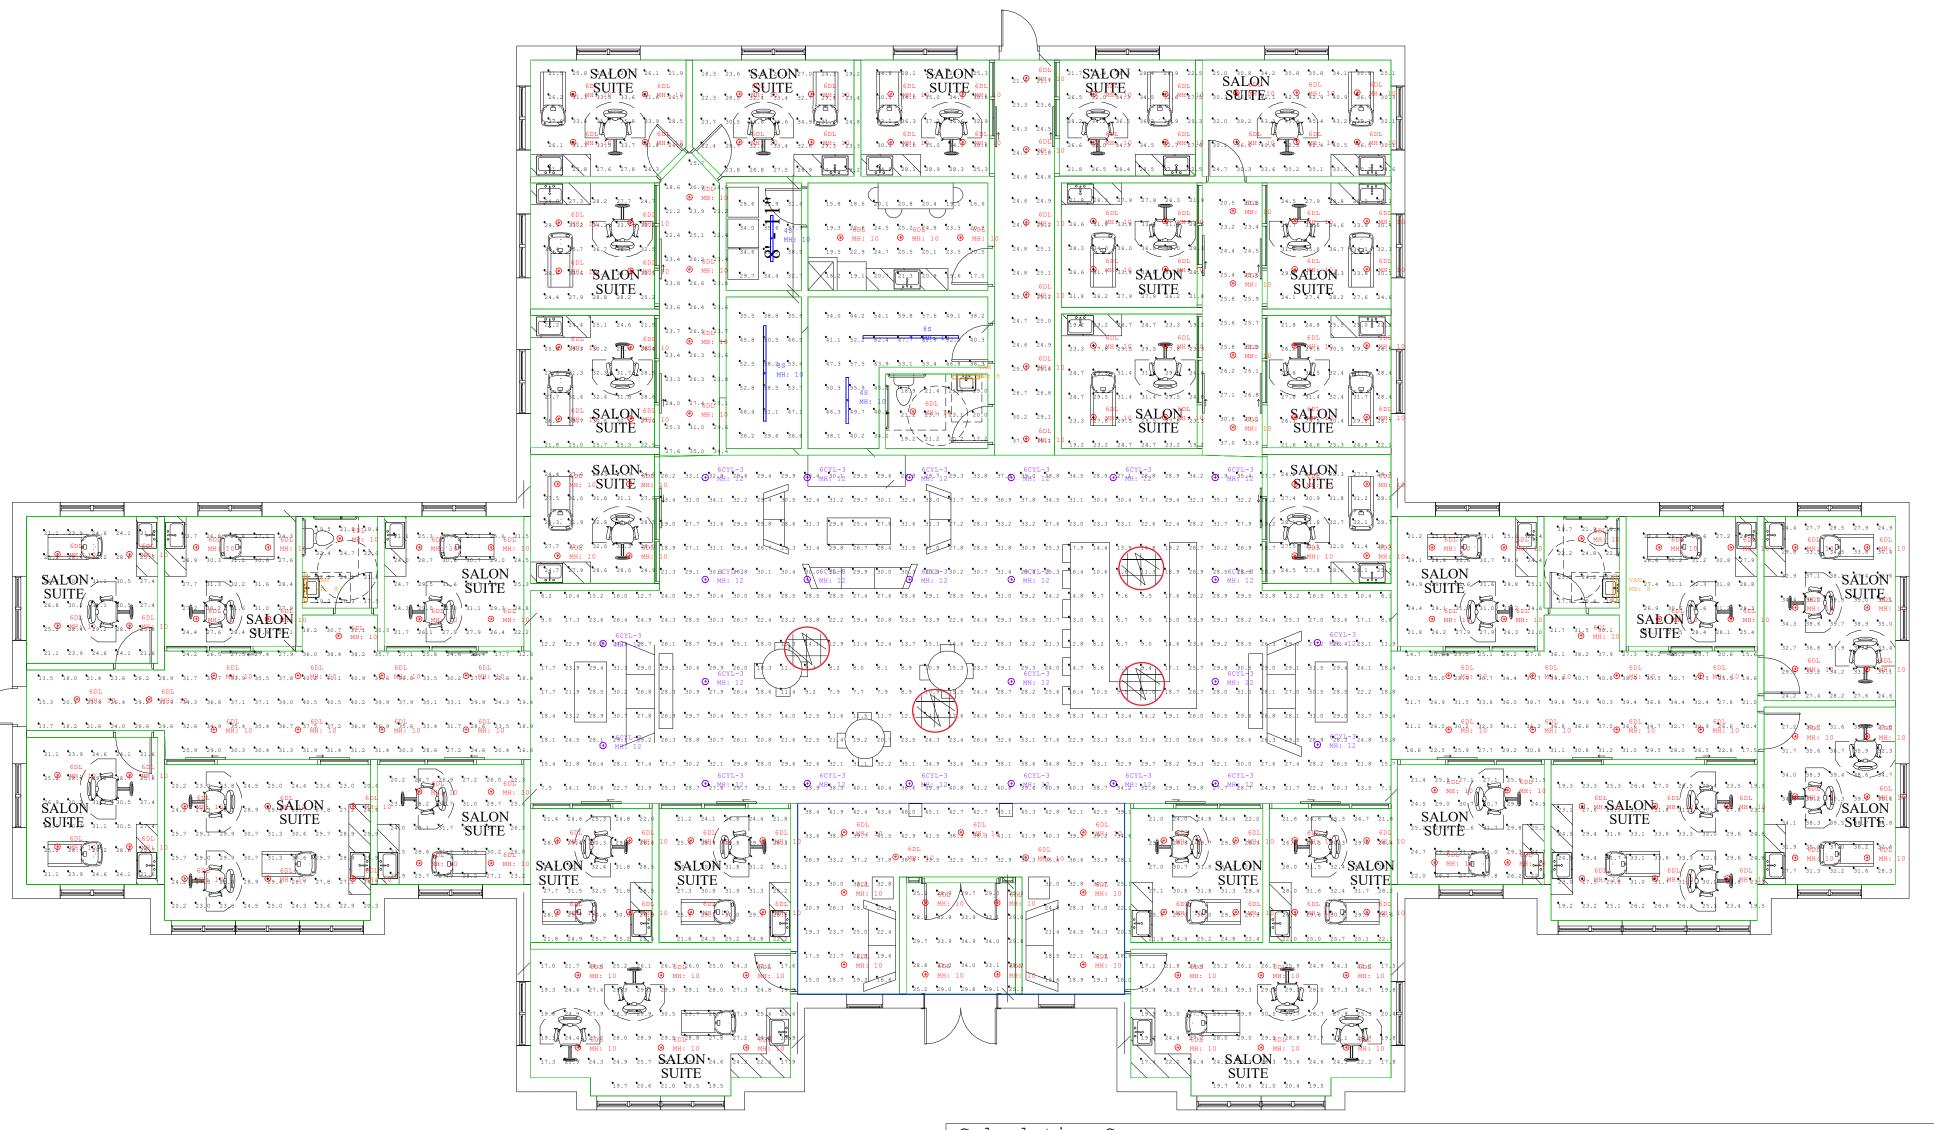

Symbol	Label	Qty	[MANUFAC]	Catalog Number	LLF	Lumens	Watts	Tot. Watts
	6CYL-3	24	Lithonia Lighting	LDN6CYL 35_20 LO6AR LSS	0.950	1982	22.52	540.48
<u>→</u>	VAN	3	Lithonia Lighting	FMVCCLS 24IN MVOLT 30K35K40K	0.950	1737	18.12	54.36
-	85	2	Lithonia Lighting	CSS L96 ALO4 MVOLT SWW3 80CRI (8000LM 4000K)	0.950	8415	68.4	136.8
→	4S	2	Lithonia Lighting	CSS L48 ALO3 (4000) MVOLT SWW3 (40) 80CRI	0.950	5095	34.81	69.62
$\frac{}{(\!$	6DL	191	Juno Lighting	WF6 DREG B ALO20 SWW5 90CRI 35K	0.950	1490	15.5	2960.5

Calculation Summary							
Label	CalcType	Units	Avg	Max	Min	Avg/Min	Max/Min
Bathroom 1_Workplane	Illuminance	FC	21.22	24.7	17.5	1.21	1.41
Bathroom 2_Workplane	Illuminance	FC	21.28	24.8	17.6	1.21	1.41
Bathroom 3_Workplane	Illuminance	FC	20.55	23.7	17.2	1.19	1.38
Breakroom_Workplane	Illuminance	FC	21.00	25.5	15.8	1.33	1.61
Corridor 1_Workplane	Illuminance	FC	24.62	35.0	15.7	1.57	2.23
Corridor 2_Workplane	Illuminance	FC	25.72	37.4	21.6	1.19	1.73
Corridor 3_Workplane	Illuminance	Fc	26.33	37.0	20.5	1.28	1.80
Corridor 4_Workplane	Illuminance	Fc	29.58	41.1	12.8	2.31	3.21
Corridor 5_Workplane	Illuminance	Fc	29.83	40.8	14.7	2.03	2.78
Lobby Reception Area_Workplane	Illuminance	Fc	25.88	46.0	6.1	4.24	7.54
Misc Room_Workplane	Illuminance	FC	46.62	58.5	35.5	1.31	1.65
Salon Suite_1_Workplane	Illuminance	Fc	28.39	32.3	23.4	1.21	1.38
Salon Suite_10_Workplane	Illuminance	Fc	27.14	31.9	21.2	1.28	1.50
Salon Suite_11_Workplane	Illuminance	Fc	27.58	32.5	21.4	1.29	1.52
Salon Suite_12_Workplane	Illuminance	Fc	27.13	32.1	20.2	1.34	1.59
Salon Suite_13_Workplane	Illuminance	Fc	26.50	31.3	20.2	1.31	1.55
Salon Suite_14_Workplane	Illuminance	Fc	26.58	31.2	21.1	1.26	1.48
Salon Suite_15_Workplane	Illuminance	Fc	26.57	31.1	21.1	1.26	1.47
Salon Suite_16_Workplane	Illuminance	FC	28.36	32.2	23.7	1.20	1.36
Salon Suite_17_Workplane	Illuminance	Fc	26.99	31.7	21.1	1.28	1.50
Salon Suite_18_Workplane	Illuminance	Fc	28.78	32.8	24.4	1.18	1.34
Salon Suite_19_Workplane	Illuminance	Fc	27.53	32.4	21.2	1.30	1.53
Salon Suite_2_Workplane	Illuminance	Fc	32.96	39.8	24.2	1.36	1.64
Salon Suite_20_Workplane	Illuminance	Fc	30.47	36.7	24.0	1.27	1.53
Salon Suite_21_Workplane	Illuminance	Fc	29.00	35.8	21.5	1.35	1.67
Salon Suite_22_Workplane	Illuminance	Fc	27.49	35.6	18.3	1.50	1.95
Salon Suite_23_Workplane	Illuminance	Fc	30.98	37.2	24.8	1.25	1.50
Salon Suite_24_Workplane	Illuminance	Fc	29.46	36.7	21.7	1.36	1.69
Salon Suite_25_Workplane	Illuminance	Fc	28.97	36.0	21.8	1.33	1.65
Salon Suite_26_Workplane	Illuminance	FC	25.93	31.4	19.2	1.35	1.64
Salon Suite_27_Workplane	Illuminance	FC	35.50	45.4	24.6	1.44	1.85
Salon Suite_28_Workplane	Illuminance	Fc	30.47	36.7	24.1	1.26	1.52
Salon Suite_29_Workplane	Illuminance	Fc	27.56	32.4	21.6	1.28	1.50
Salon Suite_3_Workplane	Illuminance	Fc	34.43	40.3	27.2	1.27	1.48
Salon Suite_30_Workplane	Illuminance	Fc	28.77	32.7	24.2	1.19	1.35
Salon Suite_4_Workplane	Illuminance	Fc	27.54	33.8	19.2	1.43	1.76
Salon Suite_5_Workplane	Illuminance	Fc	27.06	31.7	21.4	1.26	1.48
Salon Suite_6_Workplane	Illuminance	Fc	27.56	32.4	21.6	1.28	1.50
Salon Suite_7_Workplane	Illuminance	Fc	27.12	31.8	21.0	1.29	1.51
Salon Suite_8_Workplane	Illuminance	Fc	24.66	30.5	17.1	1.44	1.78
Salon Suite_9_Workplane	Illuminance	Fc	24.67	30.5	17.0	1.45	1.79
Salon Suite_Workplane	Illuminance	FC	26.98	31.6	21.2	1.27	1.49
Storage_1_Workplane	Illuminance	Fc	49.09	67.7	34.0	1.44	1.99
Storage_Workplane	Illuminance	Fc	34.55	40.3	28.6	1.21	1.41
Vestibule_Workplane	Illuminance	Fc	30.18	34.9	25.2	1.20	1.38

Revisions

QUOTE# Drawn By: Nick Rooyakkers
Date:4/3/2025
Scale: 1in = 8ft

Birch

Page 1 of 1

^{1.} Standard Reflectance of 80/50/20 unless noted otherwise

Not a Construction Document, for Design purposes only
 Standard indoor calc points @ 30" A.F.F. unless noted otherwise
 Standard outdoor calc points @ Grade unless noted otherwise
 CED Pewaukee assumes no responsibility for installed light levels due to field conditions, etc.



Fixture	Schedule							
Symbol	Label	Qty	[MANUFAC]	Catalog Number	LLF	Lumens	Watts	Tot. Watts
+	6DL	2	Juno Lighting	WF6 DREG B ALO20 SWW5 90CRI 40K	0.900	1501	15.5	31
	WP1-EM	3	Chloride	ARC-ACEM-BZ	0.900	7600	16	48
Ð	SIGN	2	Lithonia Lighting	ESXF1 ALO(3,000L) SWW2(5000K) KY DDB	0.900	3076	19.12	38.24
-	P3-3HS	5	Lithonia Lighting	RSX1 LED P1 40K R3 HS	0.900	4980	51.34	256.7
->0	SCO	2		20131LEDDMG	0.900	673	12.61	25.22
-	P3-3	3	Lithonia Lighting	RSX1 LED P1 40K R3	0.900	7096	51.34	154.02
-	P1-5	5	Lithonia Lighting	RSX1 LED P4 40K R5	0.900	16793	133.14	665.7

Calculation Summary							
Label	CalcType	Units	Avg	Max	Min	Avg/Min	Max/Min
Prop Line	Illuminance	FC	0.20	0.9	0.0	N.A.	N.A.
Sidewalk	Illuminance	FC	2.06	5.2	0.9	2.29	5.78
Site	Illuminance	Fc	2.48	4.0	1.0	2.48	4.00

1. Standard Reflectance of 80/50/20 unless noted otherwise

Not a Construction Document, for Design purposes only
 Standard indoor calc points @ 30" A.F.F. unless noted otherwise
 Standard outdoor calc points @ Grade unless noted otherwise
 CED Pewaukee assumes no responsibility for installed light levels due to field conditions, etc.

Calculation Summary							
Label	CalcType	Units	Avg	Max	Min	Avg/Min	Max/Min
Prop Line	Illuminance	Fc	0.20	0.9	0.0	N.A.	N.A.
Sidewalk	Illuminance	Fc	2.06	5.2	0.9	2.29	5.78
Site	Illuminance	Fc	2.48	4.0	1.0	2.48	4.00

Revisions

Birch

Page 1 of 1